

JON M. HUNTSMAN, JR. Governor

GARY R. HERBERT Lieutenant Governor

Department of Administrative Services

KIMBERLY HOOD Executive Director

Division of Facilities Construction and Management DAVID G. BUXTON Director

ADDENDUM #1

Date: 11 July 2007

To: Architects/Engineers

From: Matthias Mueller, Program Director, DFCM

Reference: North Temple ABC Store Expansion – 07269030

Bountiful ABC Store Reconstruction – 0727003 Taylorsville ABC Store Expansion – 06306030

Subject: Addendum No. 1

Pages Total pages 31

Note: This Addendum shall be included as part of the Agreement. Short listed firms shall acknowledge receipt of this Addendum by letter submitted at the time of their interview

SCHEDULE HAS NOT BEEN CHANGED

1.1 SHORT LISTING

At the time of the mandatory pre-proposal meeting, DFCM surveyed the representatives of the attending firms regarding the number of firms to be short listed. It was the consensus of the group that three (3) qualifying firms should be short listed by the project's selection committee. Consequently, DFCM shall short list to three firms that will be invited to participate in the interview stage.



1.2 SELECTION COMMITTEE

The selection committee is comprised of the following members:

John Freeman – ABC Director of Operations

Kurt Baxter – DFCM Program Director

Robyn Smith – Architect with HFS Architects

Rod Lewis – Project Manager with Broderick Henderson

1.3 QUESTIONS

Question 1:What are the addresses of the stores?

Answer: North Temple store – 1255 West North Temple, Salt Lake City;

Bountiful store – 70 South 500 West, Bountiful;

Taylorsville store – 3905 West 5400 South, Taylorsville.

Question 2:In what directions did the state anticipate expanding the North

Temple and Taylorsville stores?

Answer: North Temple – there is land to the south for expansion;

Taylorsville - there is also property to the south for expansion.

Question 3: Are plans of the existing North Temple and Taylorsville stores available

for our review?

Answer: The electronic documents for the stores are attached to this addendum

End of Addendum



T-1	
	TITLE SHEET, INDEX, LEGEND & SYMBOLS
C-1	SITE PLAN AND DETAILS
LS-1	LANDSCAPE SPRINKLER PLAN AND DETAILS
LS-1	LANDSCAPE PLANTING PLAN AND DETAILS
A-1	FLOOR PLAN AND DETAILS
A-2	EXTERIOR ELEVATIONS AND DETAILS
A-3	BUILDING SECTION, REAR ELEVATION, AND DETAILS
A-4	FINISH AND DOOR SCHEDULES, REFLECTED CEILING PLAN, AND DETAILS
S-1	FOOTING AND FOUNDATION PLAN, ROOF FRAMING PLAN, AND DETAILS
S-2	STRUCTURAL NOTES AND DETAILS
M-1	MECHANICAL AND PLUMBING PLANS AND DETAILS
M-2	MECHANICAL NOTES AND DETAILS
E-1	ELECTRICAL SITE PLAN AND DETAILIS
E-2	ELECTRICAL PLAN AND FIXTURE SCHEDULE

NEW BUILDING FOR:

STATE LIQUOR STORE

ALCOHOLIC BEVERAGE CONTROL DFCM PROJECT NO. AB96147

1255 WEST NORTH TEMPLE SALT LAKE CITY, UTAH

ARCHITECTS:

VINCENT DESIGN GROUP INC.

401 EAST 1700 SOUTH SALT LAKE CITY; UTAH (801) 484-2046

CONSULTANTS:

MECHANICAL:

GERALD D. SMITH & ASSOCIATES

(801) 262-6295

ELECTRICAL:

THOMAS & KOLKMAN ENGINEERING CO. INC.

(801) 484-8161

STRUCTURAL:


LARSEN & MALMQUIST CONSULTING ENGINEERS

(801) 972-2634

LANDSCAPE:


TIMPANOGOS LAND DESIGN

(801) 485-1217

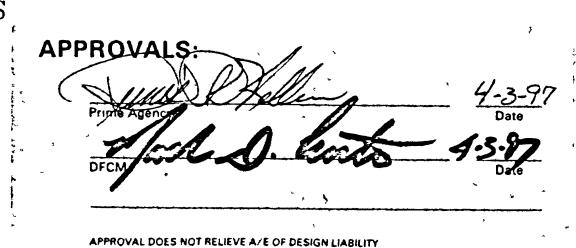

ACOUST. ACOUSTIC SPECIFICATION SPEC ADJUSTABLE STEEL STL ALUMINUM TRUSS JOIST ALUM TJI CER.TILE CERAMIC TILE REQUIRED REQ CONCRETE CONC. WATER CLOSET WCCONTINUOUS CONT. DET. DETAIL ELEV. **ELEVATION** EXISTING EXIST/EX EXPANSION EXP FLOOR PROPERTY LINE FLR P/L FINISH GRADE ELEVATION FLOOR DRAIN FGE F.D TOP OF CURB ELEVATION GALV GALVANIZED TBC GUAGE TCE TOP OF CONCRETE ELELVATION FINISH FLOOR ELEVATION GYPSUM BOARD GYP BD. FFE GAS LINE INSULATION —- G — INSUL SANITARY SEWER LINE —SS— MAXIMUM WATER LINE MM MINIMUM ---W---METAL MTL NOT IN CONTRACT NIC OPN'G **OPENING** REINFORCED REINF SHEET SHT ON CENTER O.C.

	STEEL		WINDOW NUMBERS
,	CONCRETE		DOOR NUMBERS
	ACOUSTIC TILE		DOOK HOMBENS
	GYPSUM BOARD	DETAIL NUMBER SHEET	DETAIL
	BRICK VENEER	NUMBER .	, , , , , , , , , , , , , , , , , , ,
	RIGID INSULATION	SECTION LETTER	SECTION OR SELEVATION
· ·	WOOD DEMENSIONAL LUMBER	SHEET NUMBER	
	WOOD		
		7 .	

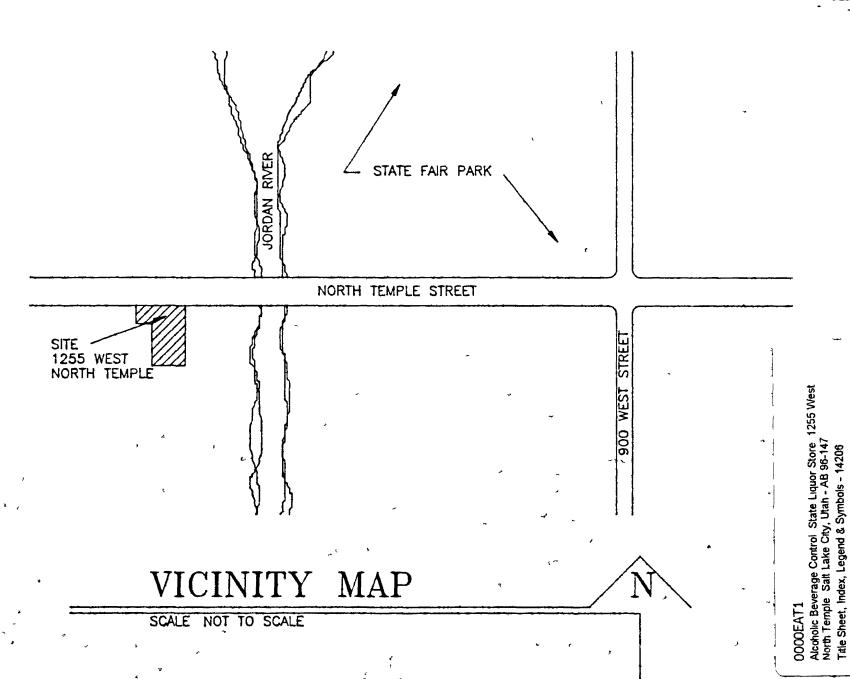


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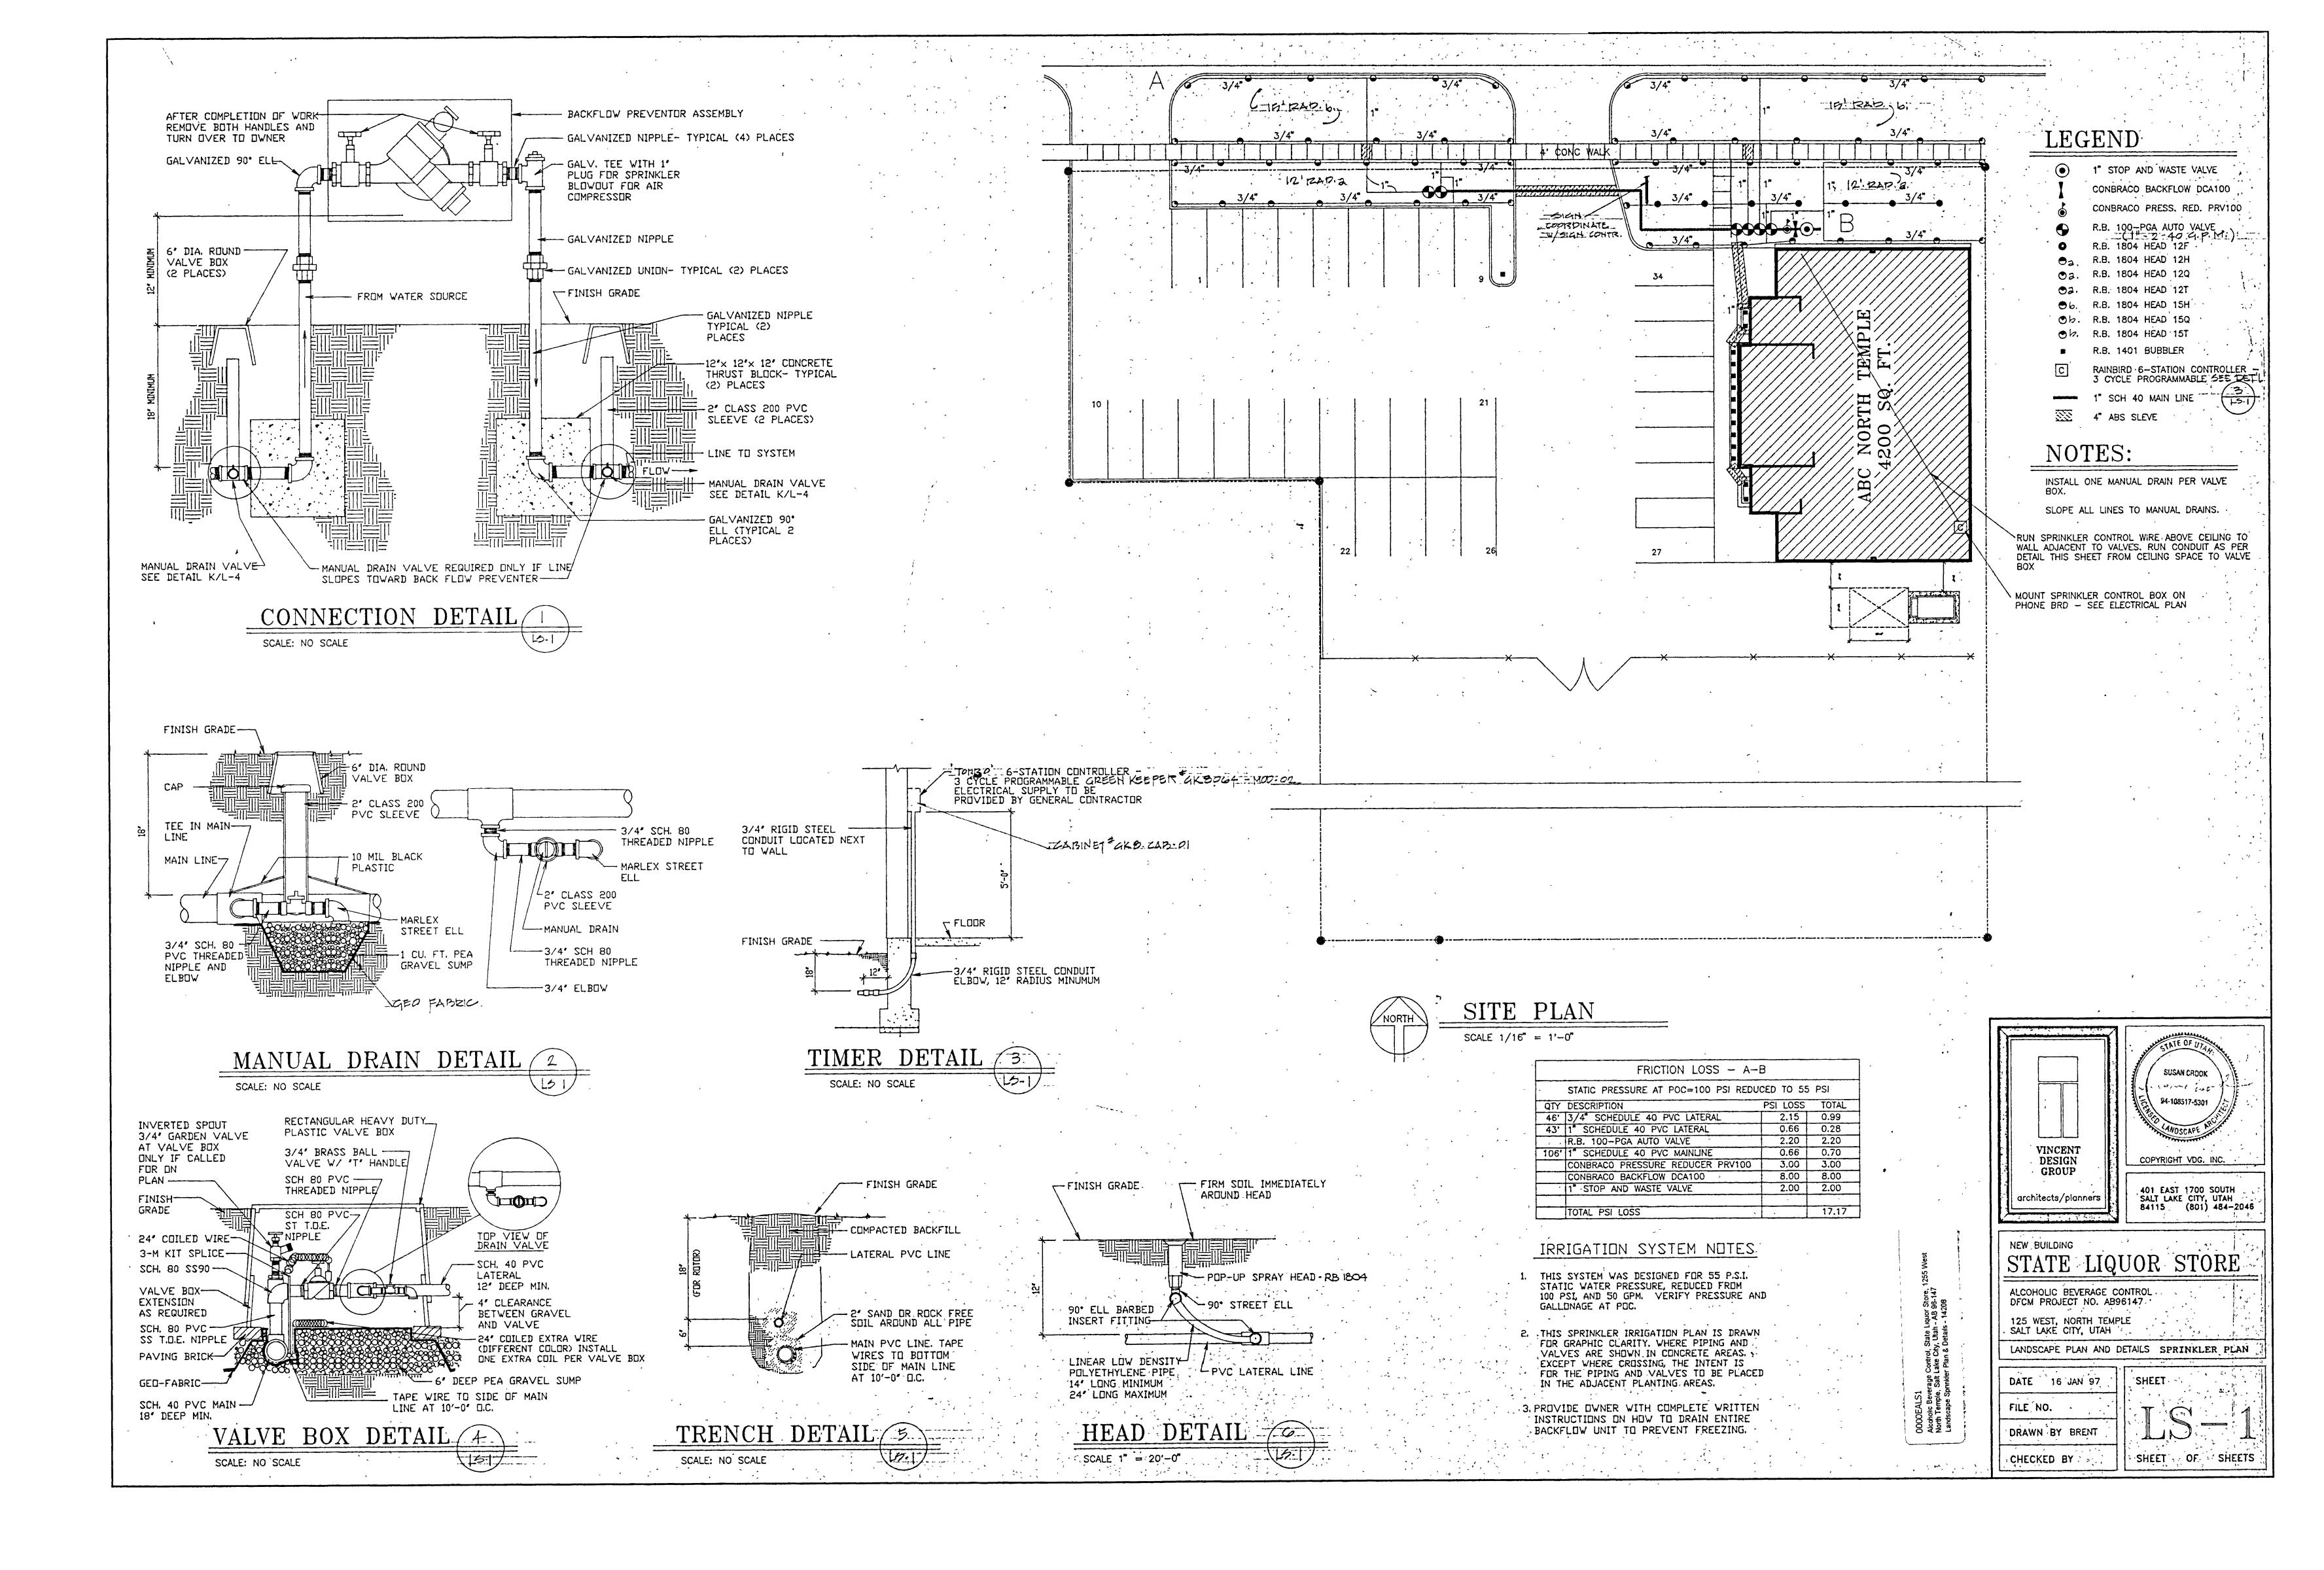



Division of Facilities C	Construction and Management								
Larry Nacestate Ash									
PROJECT MANUAL: Gen. Cond. / Notice To Contractor & Proposal	Structural Date 1/3 (G Date Lactrical Date Date								
Som I Ant 4/2	lan								
Civilismo Della 4/5	4'3'9								
OTHER AGENCIES	Electrical Date								
Agency / Institution Meintenance	Fire Marshall Date								


	Fee A/E Attach and fill in applicable data for each drawing submittal)								
Ur Pli	piceble Codes, storm Building Code anning & Design Criteria to Prevent chitectural Barriers for the Aged and a Physically Handicapped	Year 1994 Uniform Mechanical Code Utah Plumbing Code Model Energy Code National Electrical Code 1994							
À	Occupancy and Group ^a								
	Change in Useb Yes No	Mixed Occupancy ^b Yes No							
8	Type of Constructions (Circle): 1 FR	# 1 H H H W V V V FR. 1HR N 1HR N							
Ç	Location on Property® FR Ext Wa	Ills (Hrs.) Ext. Wall Opening(s) Protection (Hrs.)							
Ď	Occupancy separation ^d required (Hrs Sprinklered Indicate Yes or No								
	Stones* 1 or multiple	C THE STREET STREET STREET							
	a Actual Area (h²) * b Basic allowable aread*								
	c Allowable Area Increase	% Area (h²) % Area (h²) % Area (
	due to side yards N *								
	, W								
	, \$								
	 Side yard area increase^d (ft²) Accumulative sub-total (b + d) 								
	Sprinkier area increase (x 3 single	ei .							
	(x 2 mult								
	Total Allowable Aread for a single story								
*	x 2 for multi-story buildings								
	f Rabo! - a/e ~								
	(Actual divided by allowable)	4							
E	Fire Resistive Requirementsco & 9 (f	Hirs) (1 Hir, 2Hr 3Hr 4 Hr N H.T.)							
	Extenor Bearing Walls	Floors Ceiling Floors							
	Intenor Bearing Walls	Roots Ceiling Roofs							
	Exterior Non-bearing Walls Structural Frame	Exterior Doors and Windows							
		Shaft Enclosures							

•	VINCENT DESIGN GROUP architects/planners NEW BUILDING FOR STATE LIC ALCHOLIC BEVERAGE CONDECT NO AB9 1255 WEST NORTH TEMES SALT LAKE CITY, UTAH	6147
r	TITLE SHEET, INDEX, LEG	END & SYMBOLS
ř	DATE MAR 11, 1997	SHEET
è E	FILE NO. 96-53	
	DRAWN BY TJP	
	CHECKED BY	SHEET OF SHEETS



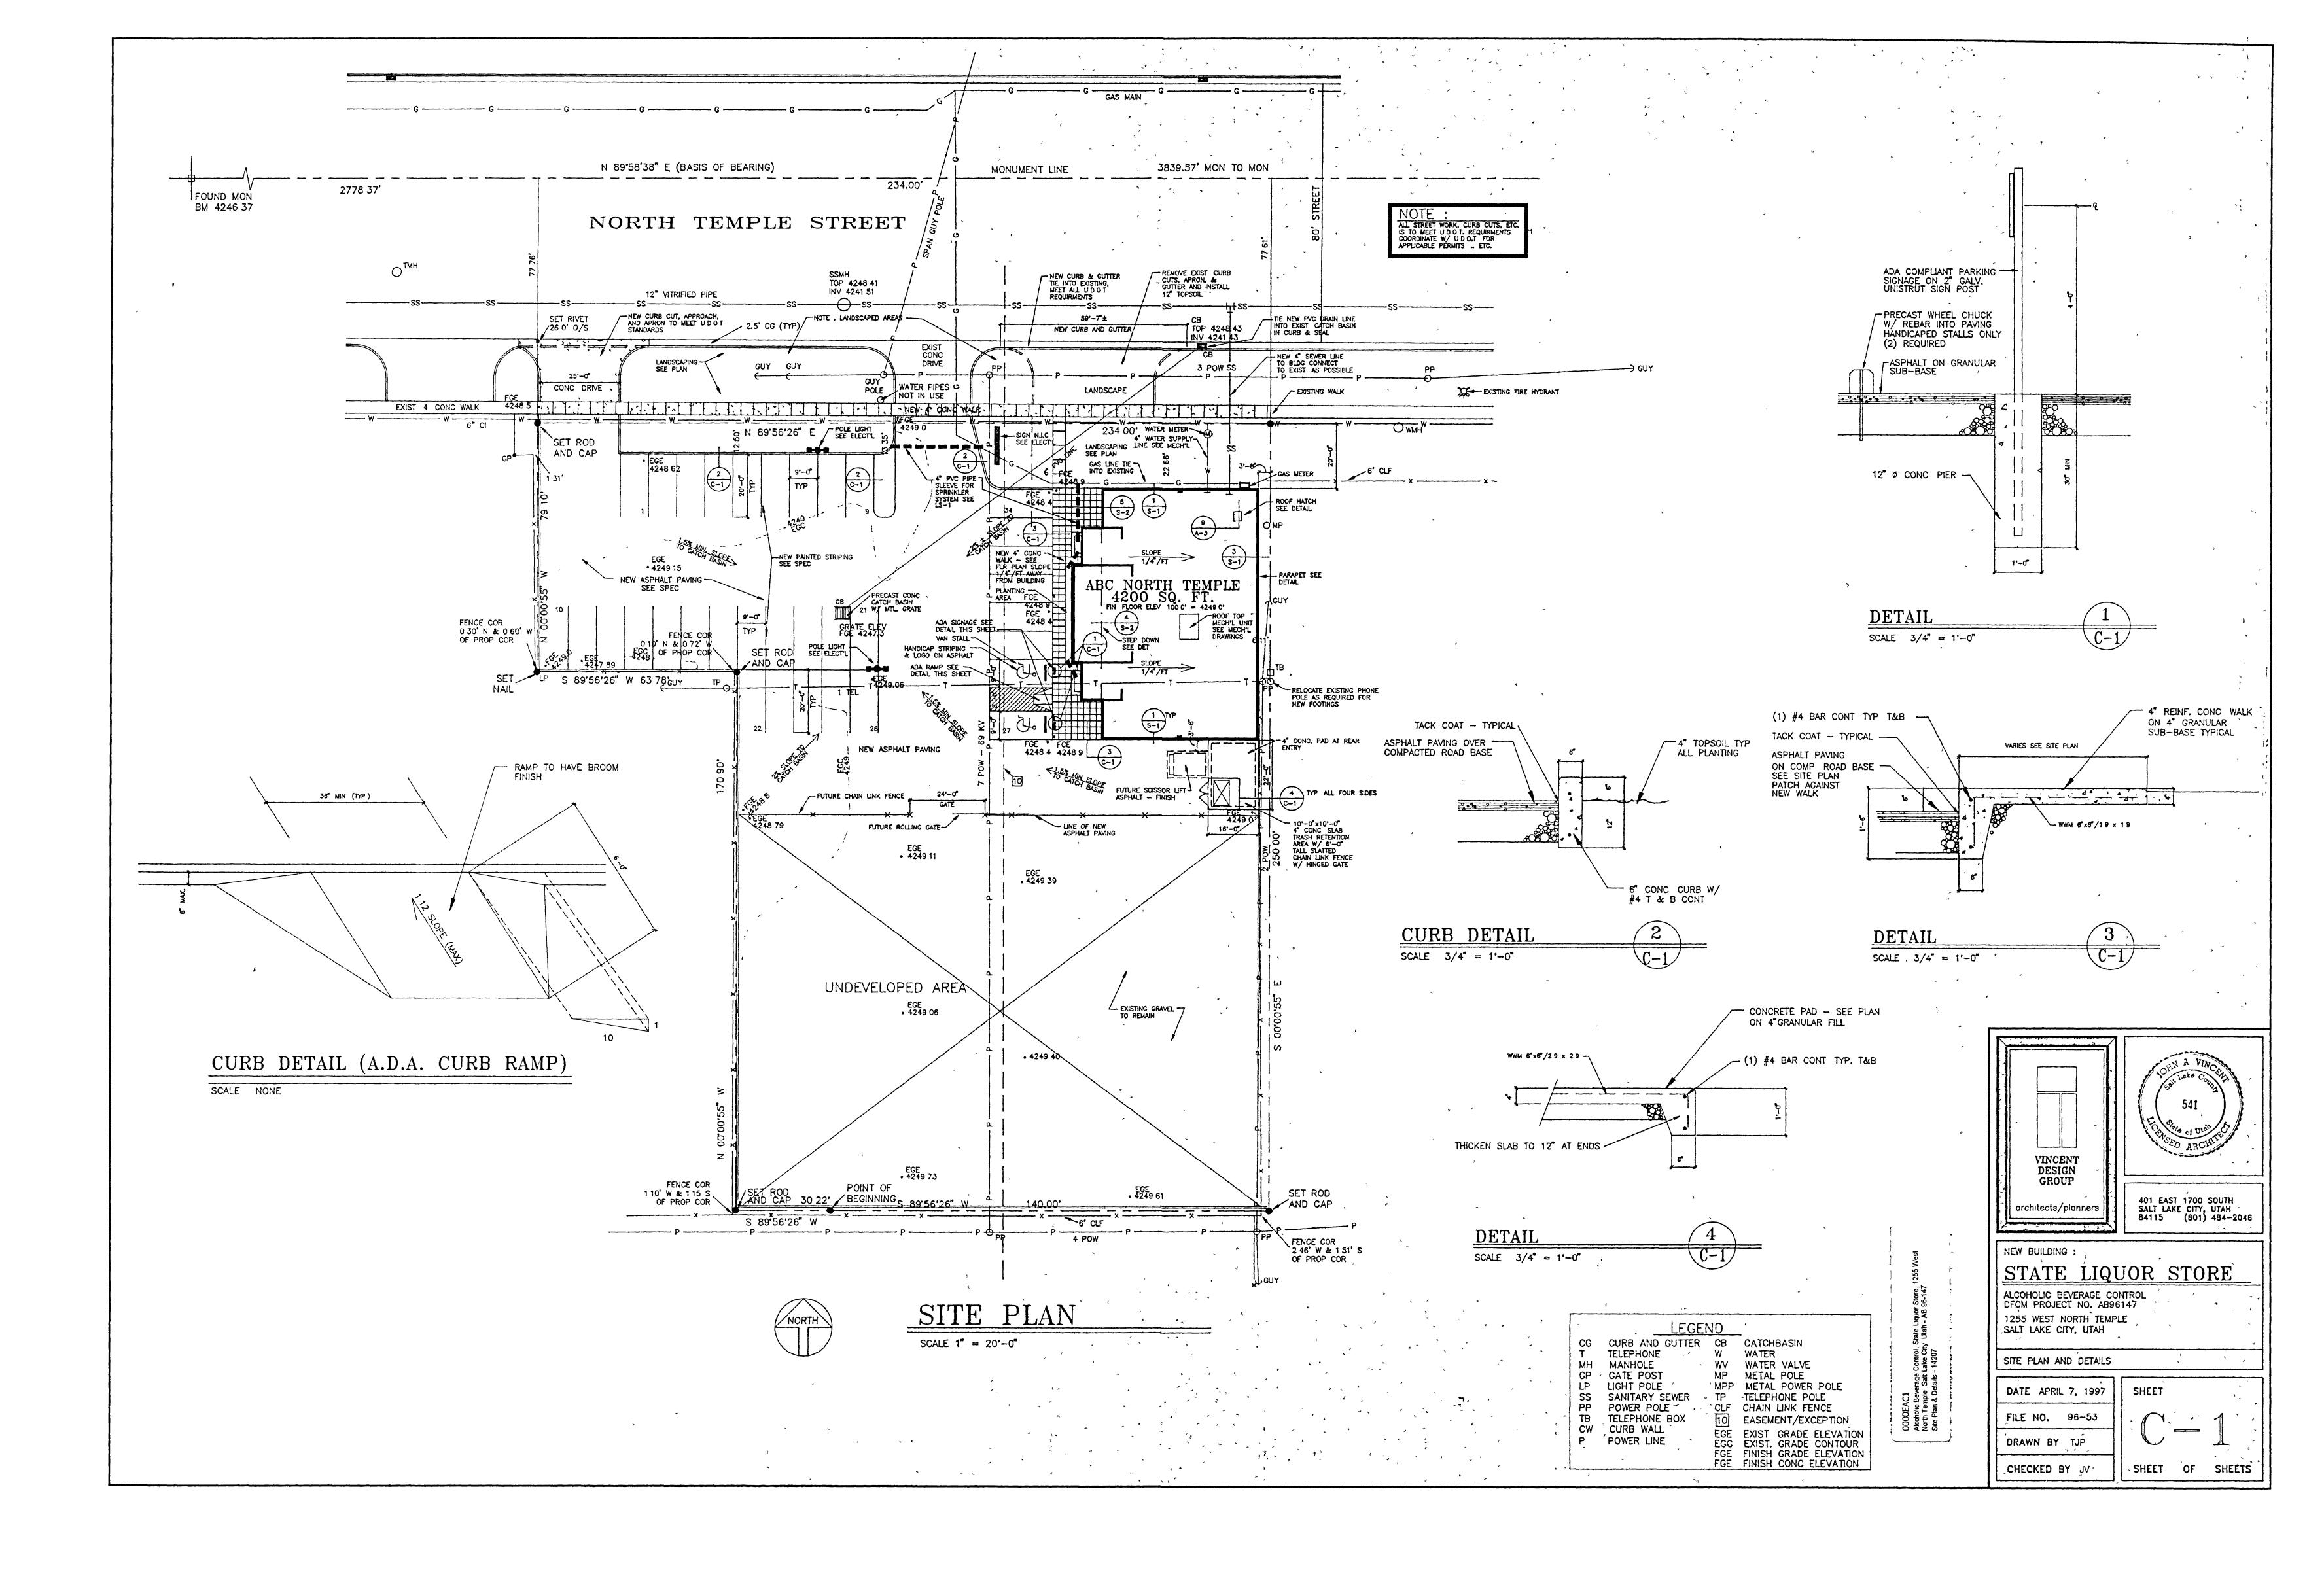


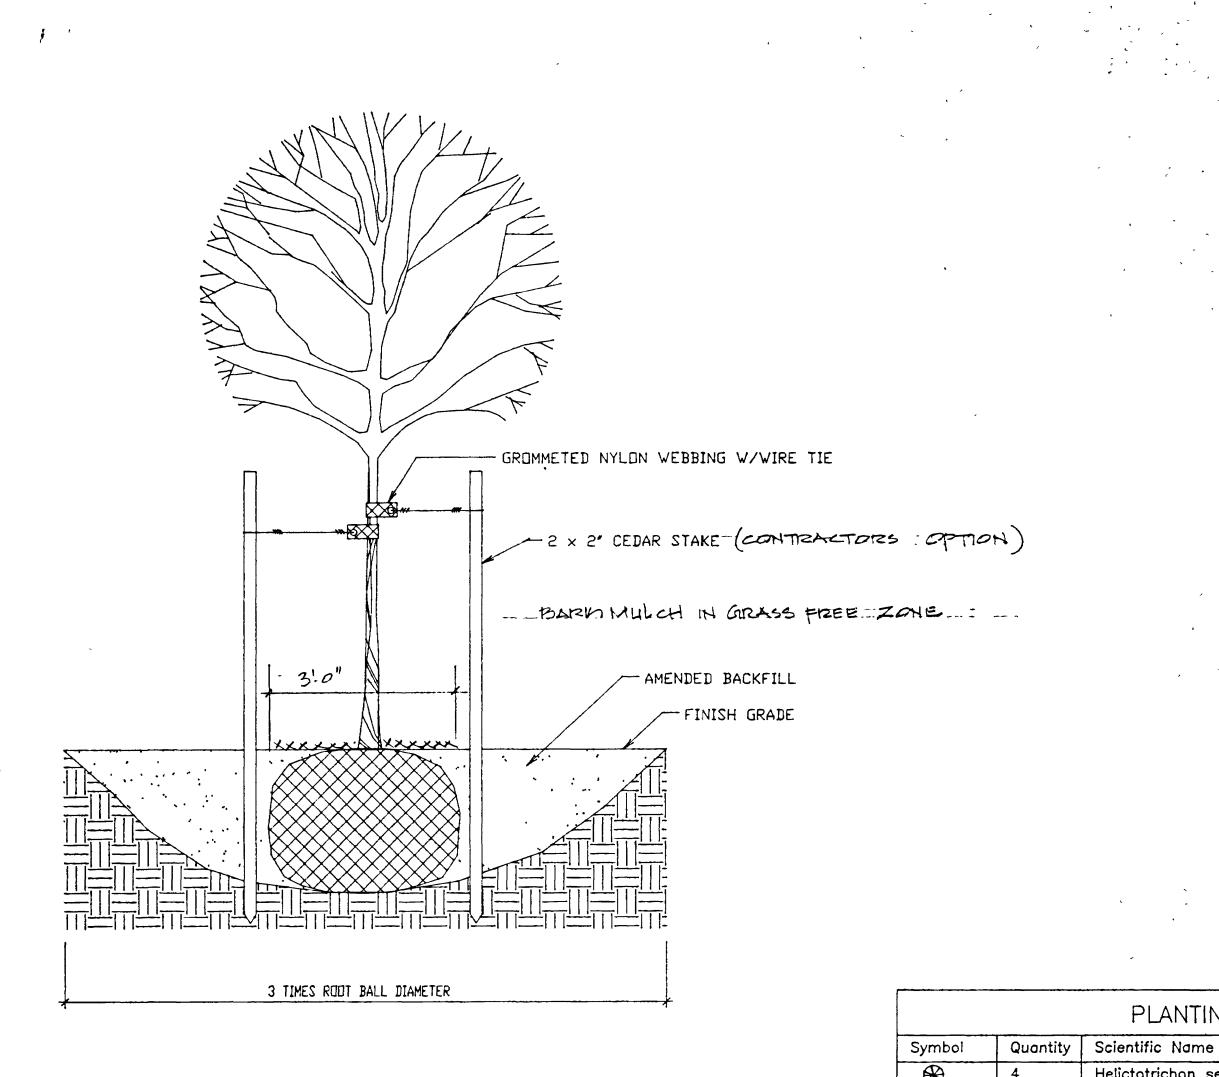

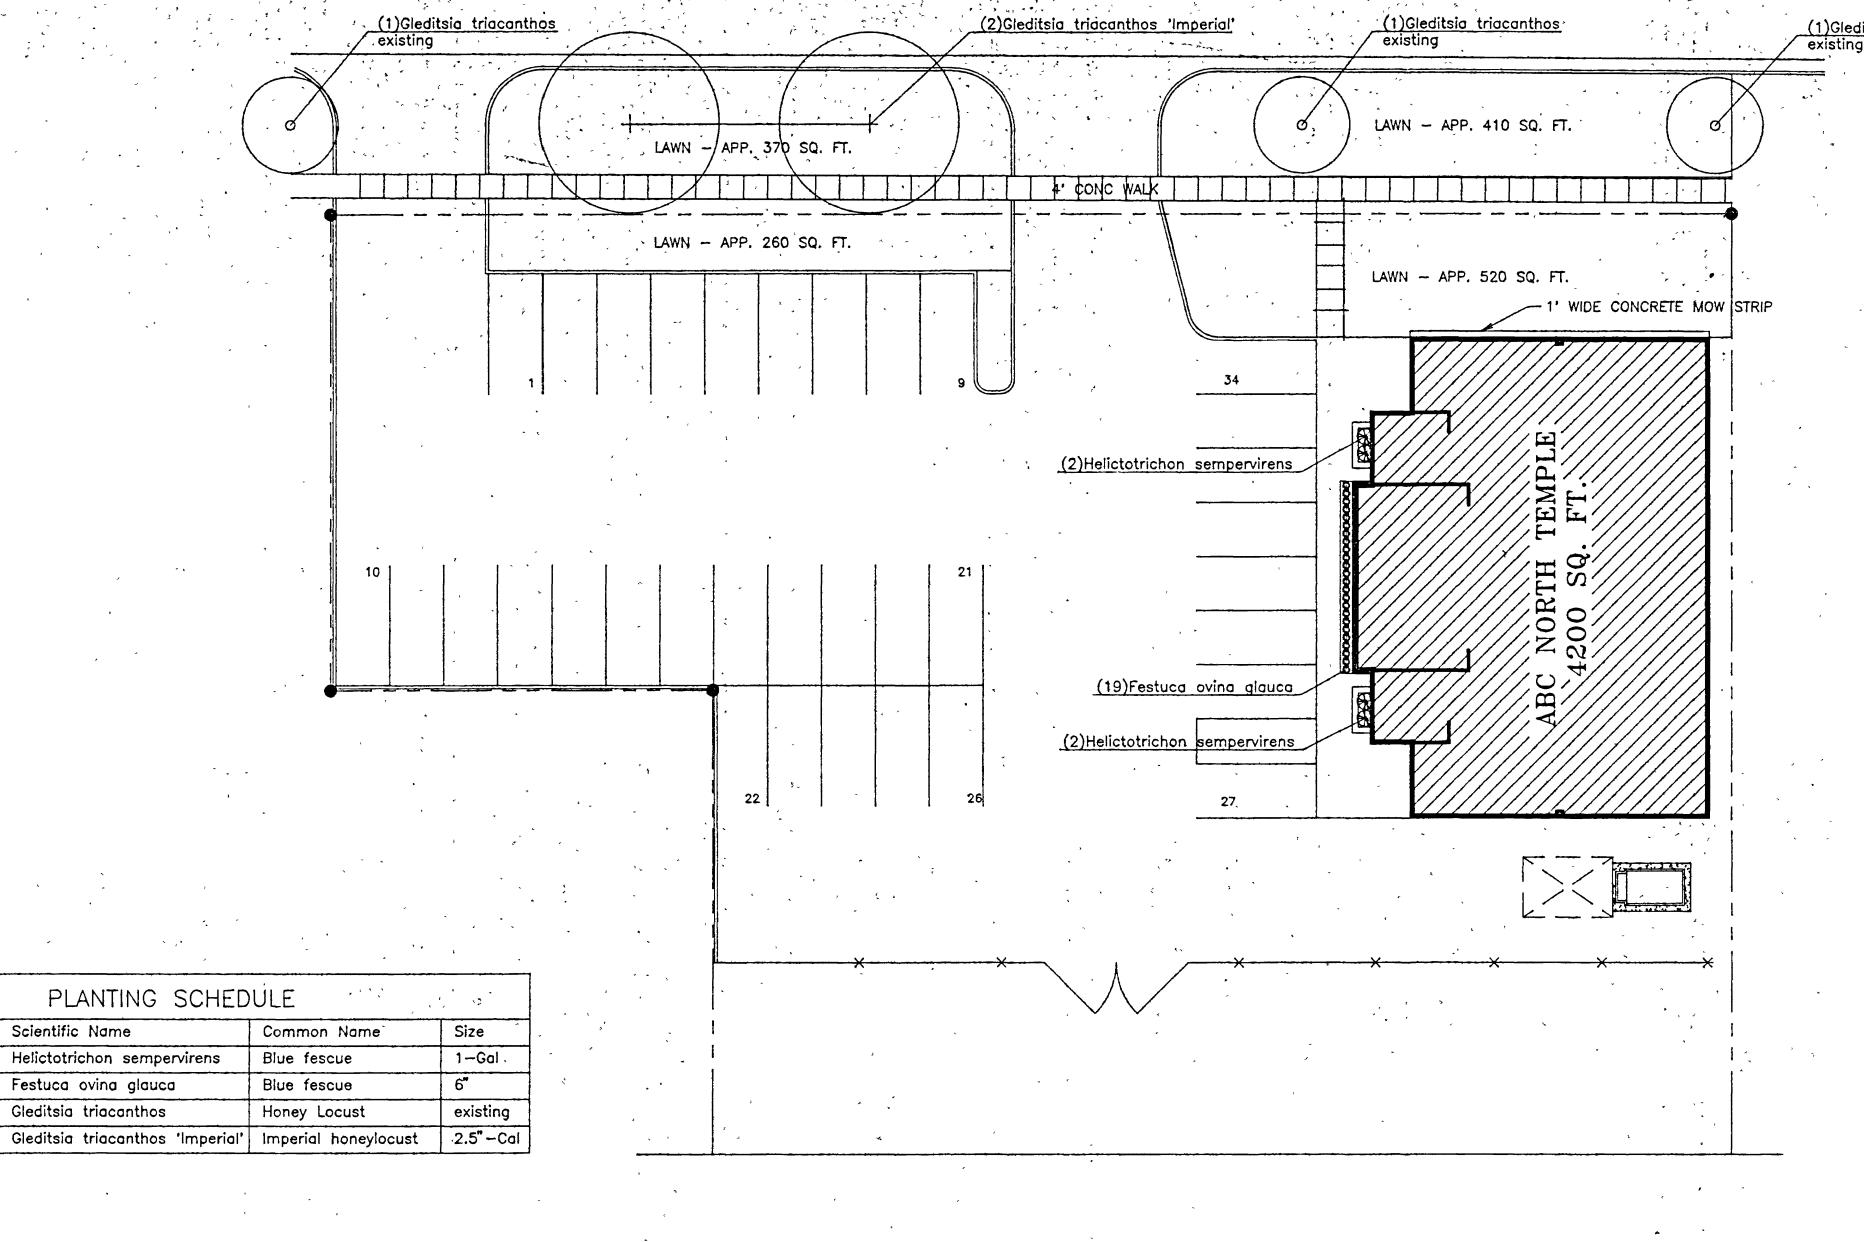

TREE PLANTING DETAIL

SCALE: NO SCALE

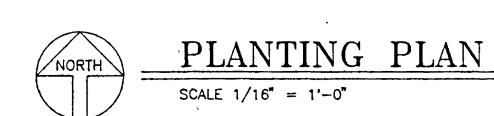

MAINTENANCE NOTES

Gleditsia triacanthos

- 1. 'BONSAI' FESCUE REQUIRES ABOUT HALF THE FERTILIZER AND WATER OF BLUEGRASS. MOW TO A HEIGHT OF 2 2 1/2'. WATER DEEPLY AND INFREQUENTLY. APPLY A COMPLETE FERTILIZER IN THE FALL.
- 2. PRUNE EXISTING HONELOCUSTS TO REMOVE BROKEN AND CROSSED BRANCHES. LIMB UP TO 8 FEET FOR PEDESTRIAN ACCESS.
- . 3. REMOVE TREE STAKES AND TIES AFTER 1 YEAR (CONTRACTOR OPTION)
- 4. MAINTAIN TREE RINGS WITH MIN. 3' RADIUS FROM TRUNK.
- 5. CUT BACK BLUE DAT GRASS TO BASE EACH SPRING.
- 6. TOPDRESS PLANTERS WITH 7 3" BARK MULCH EACH SPRING.

PLANTING NOTES

1. SOD TO BE 'BONSAI' FESCUE.
'BONSAI' FESCUE IS AVAILABLE FROM LAKE MOUNTAIN FARMS
9980 S. STATE ST.
SANDY, UT 84070 801-562-9090


PD BDX 191037 BDISE, ID 83719 808-888-3760 CDNTACT: DARWIN MCKAY


- 2. CUT TREE RINGS WITH MIN. 3' RADIUS FROM TRUNK AROUND ALL TREES AFTER INSTALLING SOD.
- 3. TOPDRESS PLANTERS WITH 3" BARK MULAH AFTER PLANTING.





SUSAN CROOK


NEW BUILDING STATE LIQUOR STORE ALCOHOLIC BEVERAGE CONTROL DECM PROJECT NO. AB96147 125 WEST, NORTH TEMPLE SALT LAKE CITY, UTAH LANDSCAPE PLAN AND DETAILS PLANTING PLAN DATE 4, 16 JAN 97 FILE NO. DRAWN BY BRENT . CHECKED BY SHEET OF SHEETS

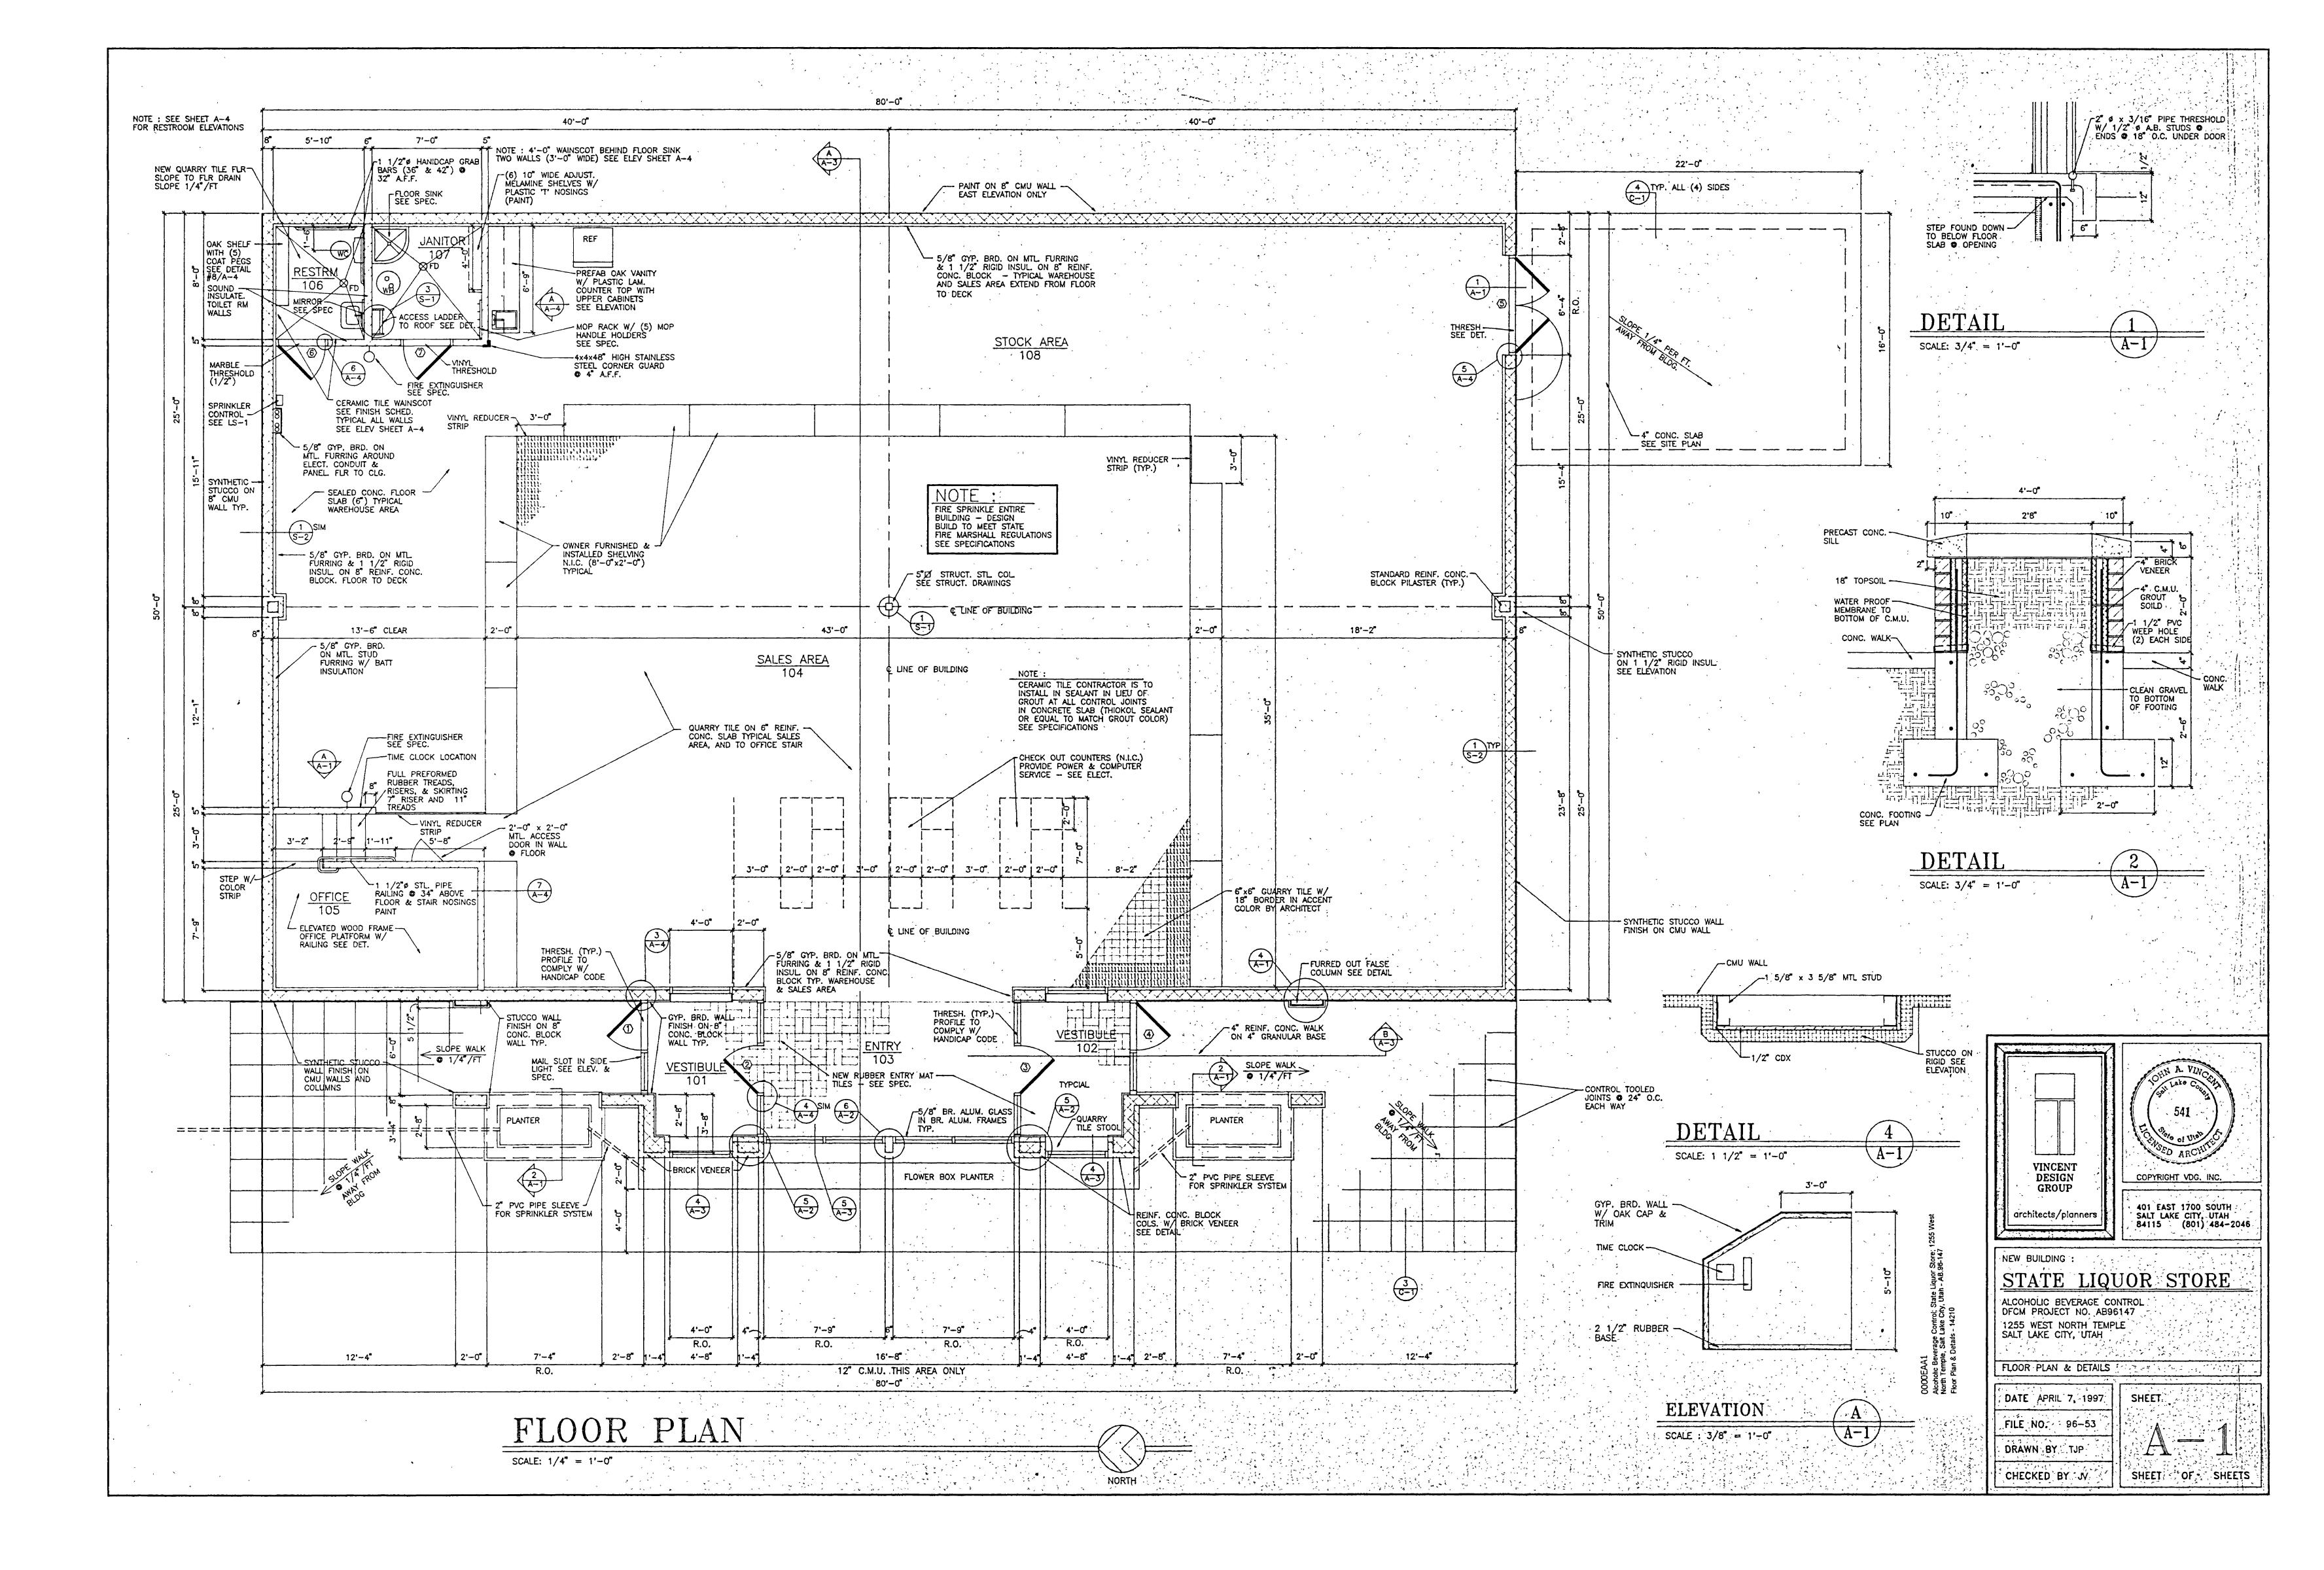

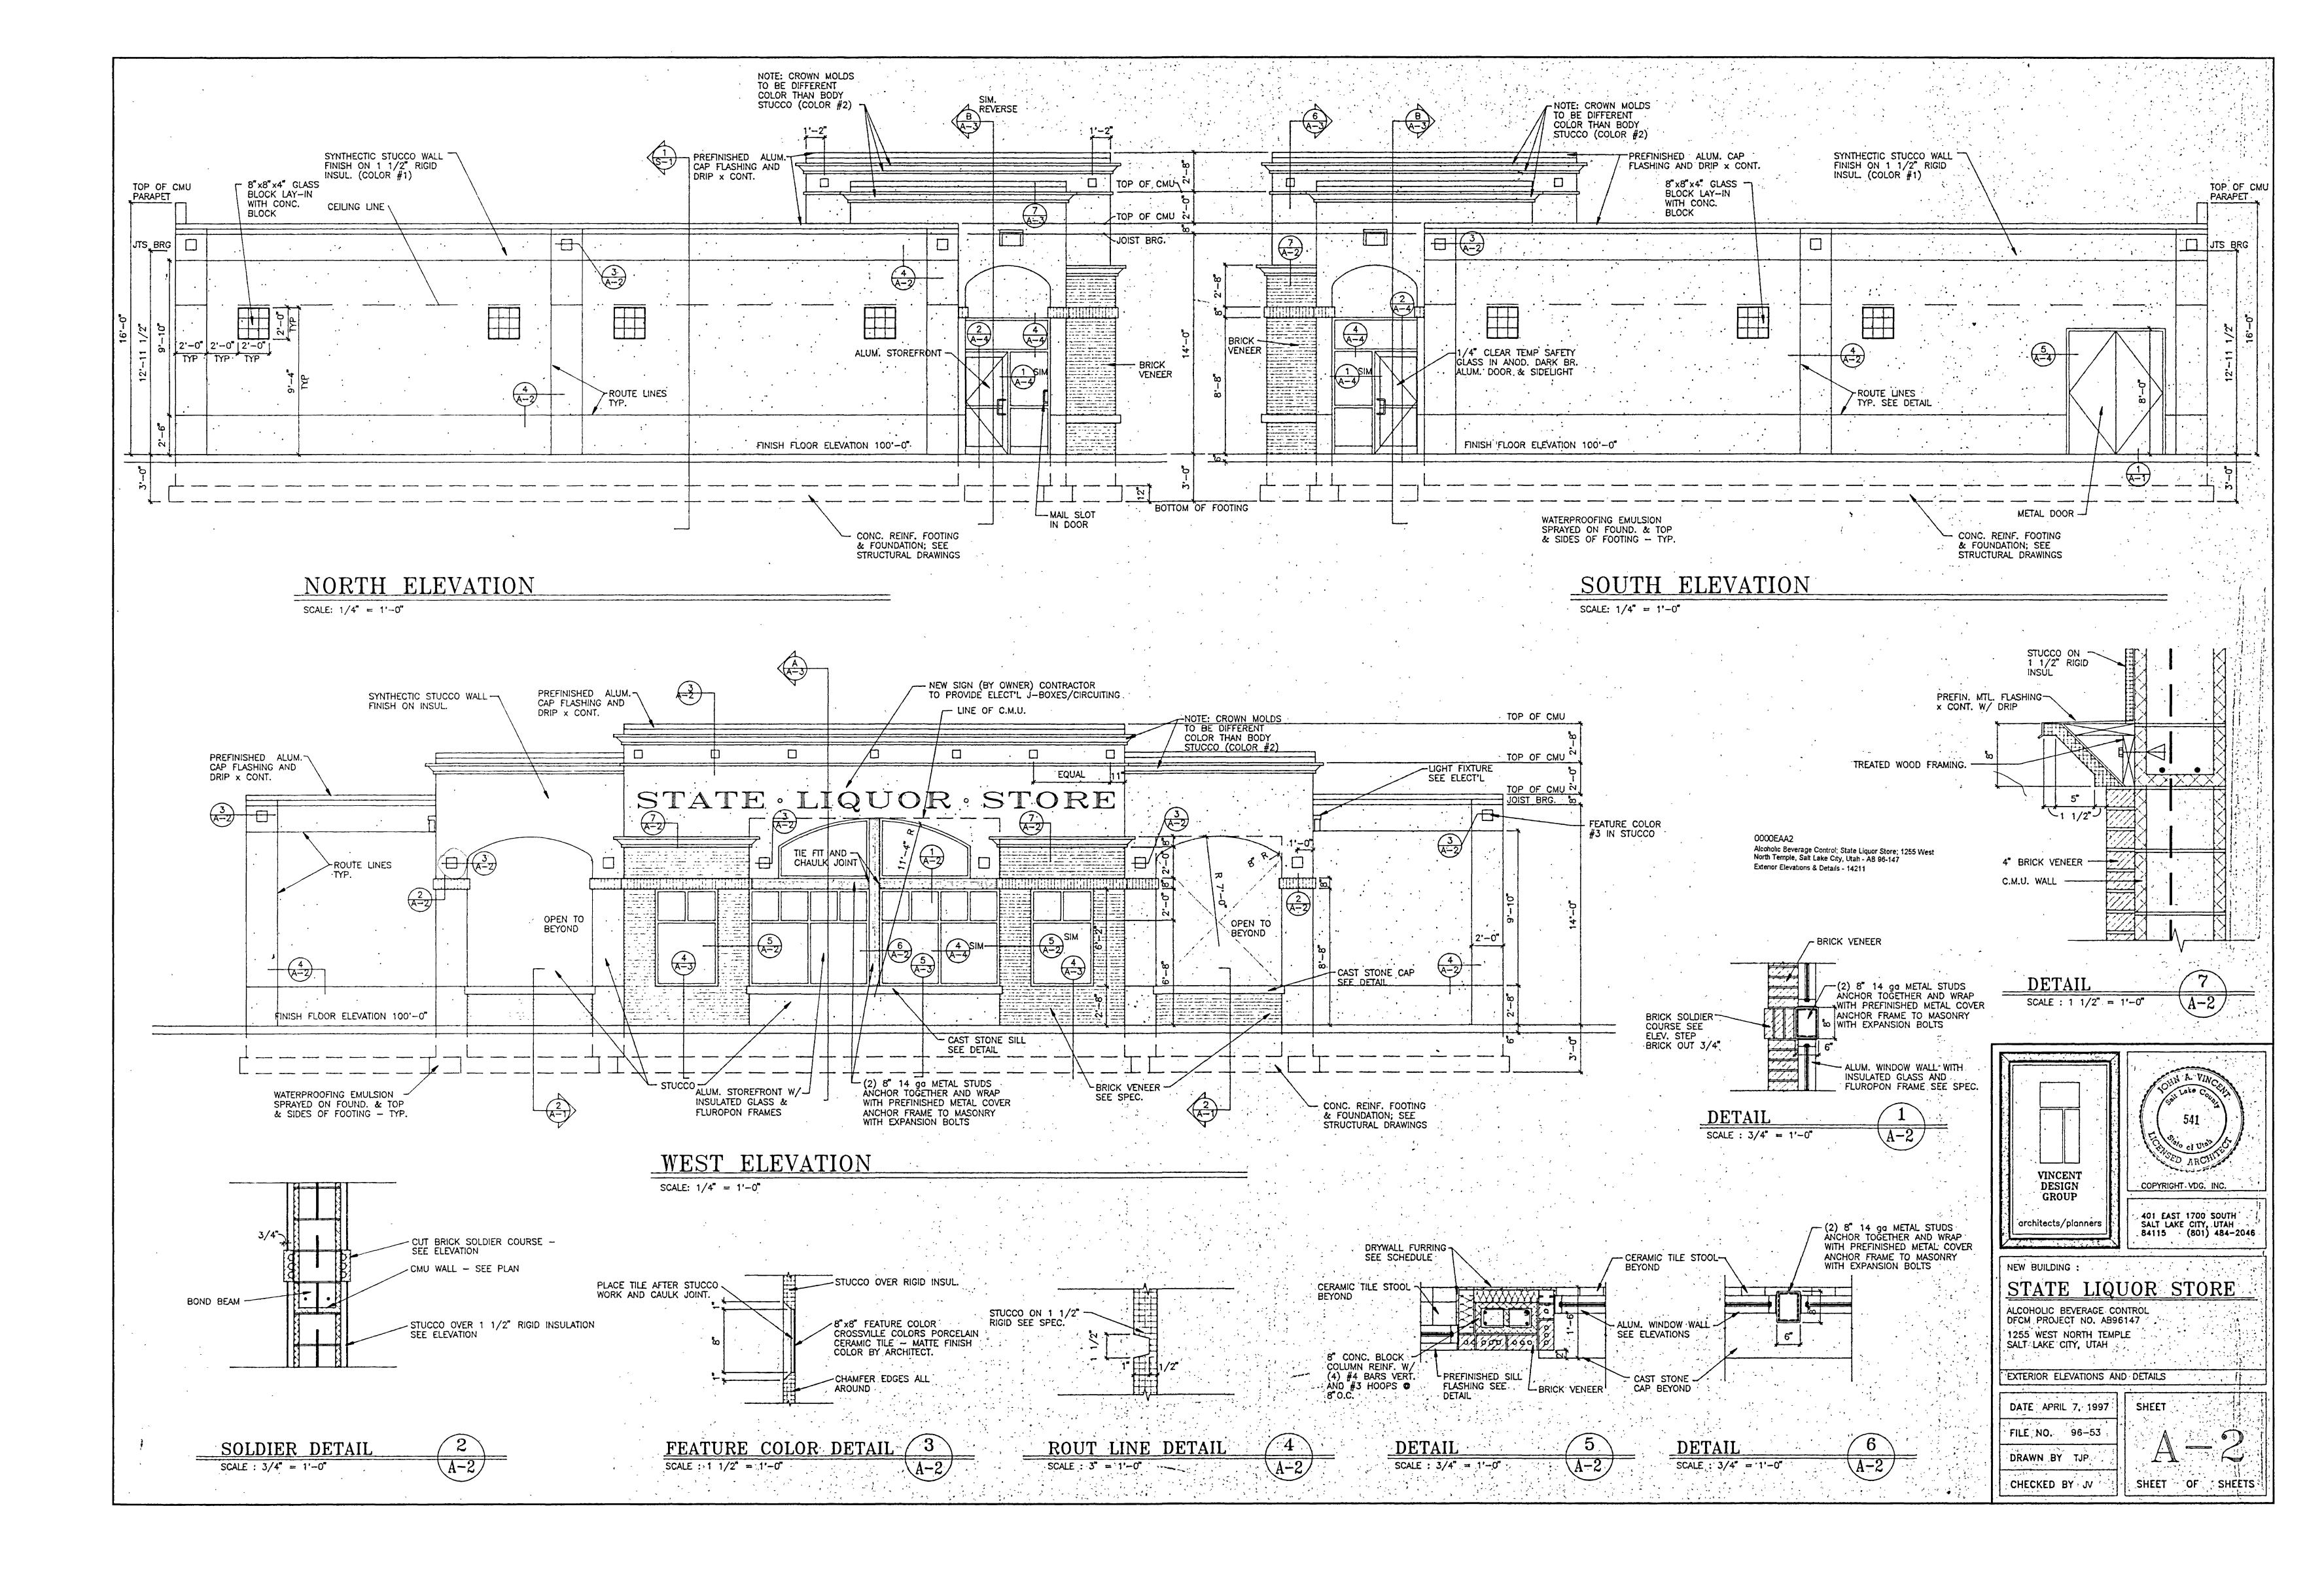

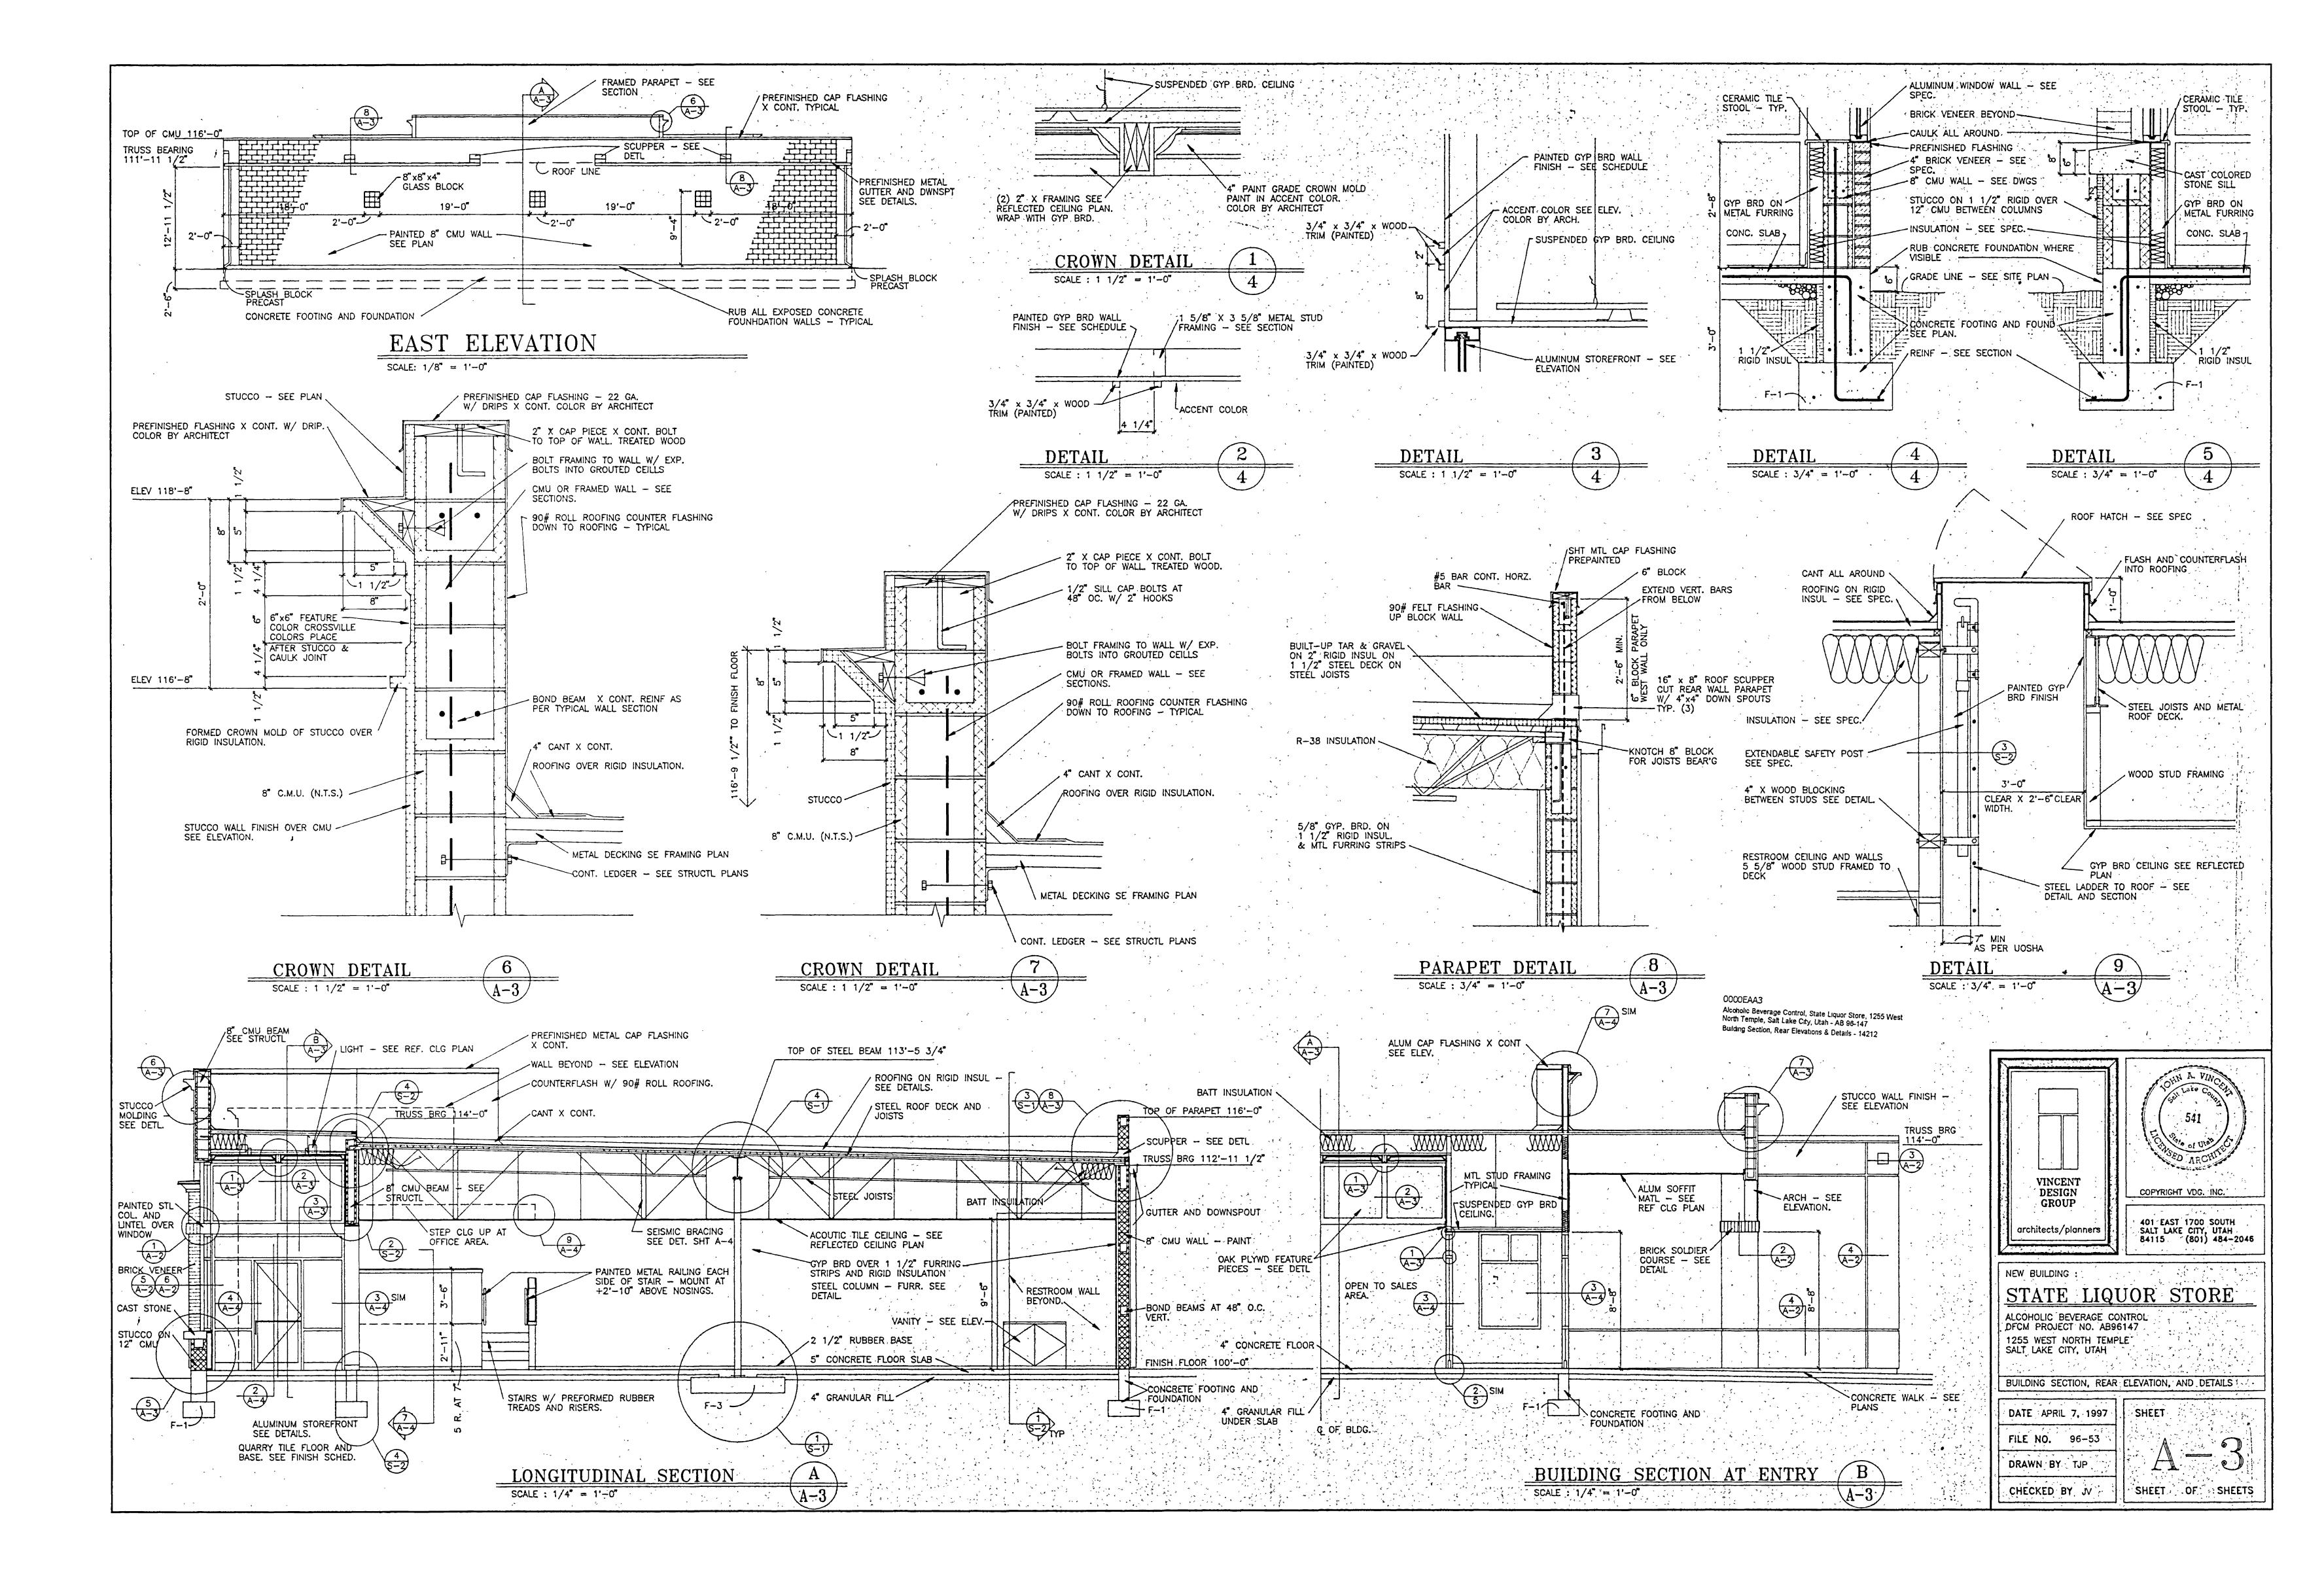

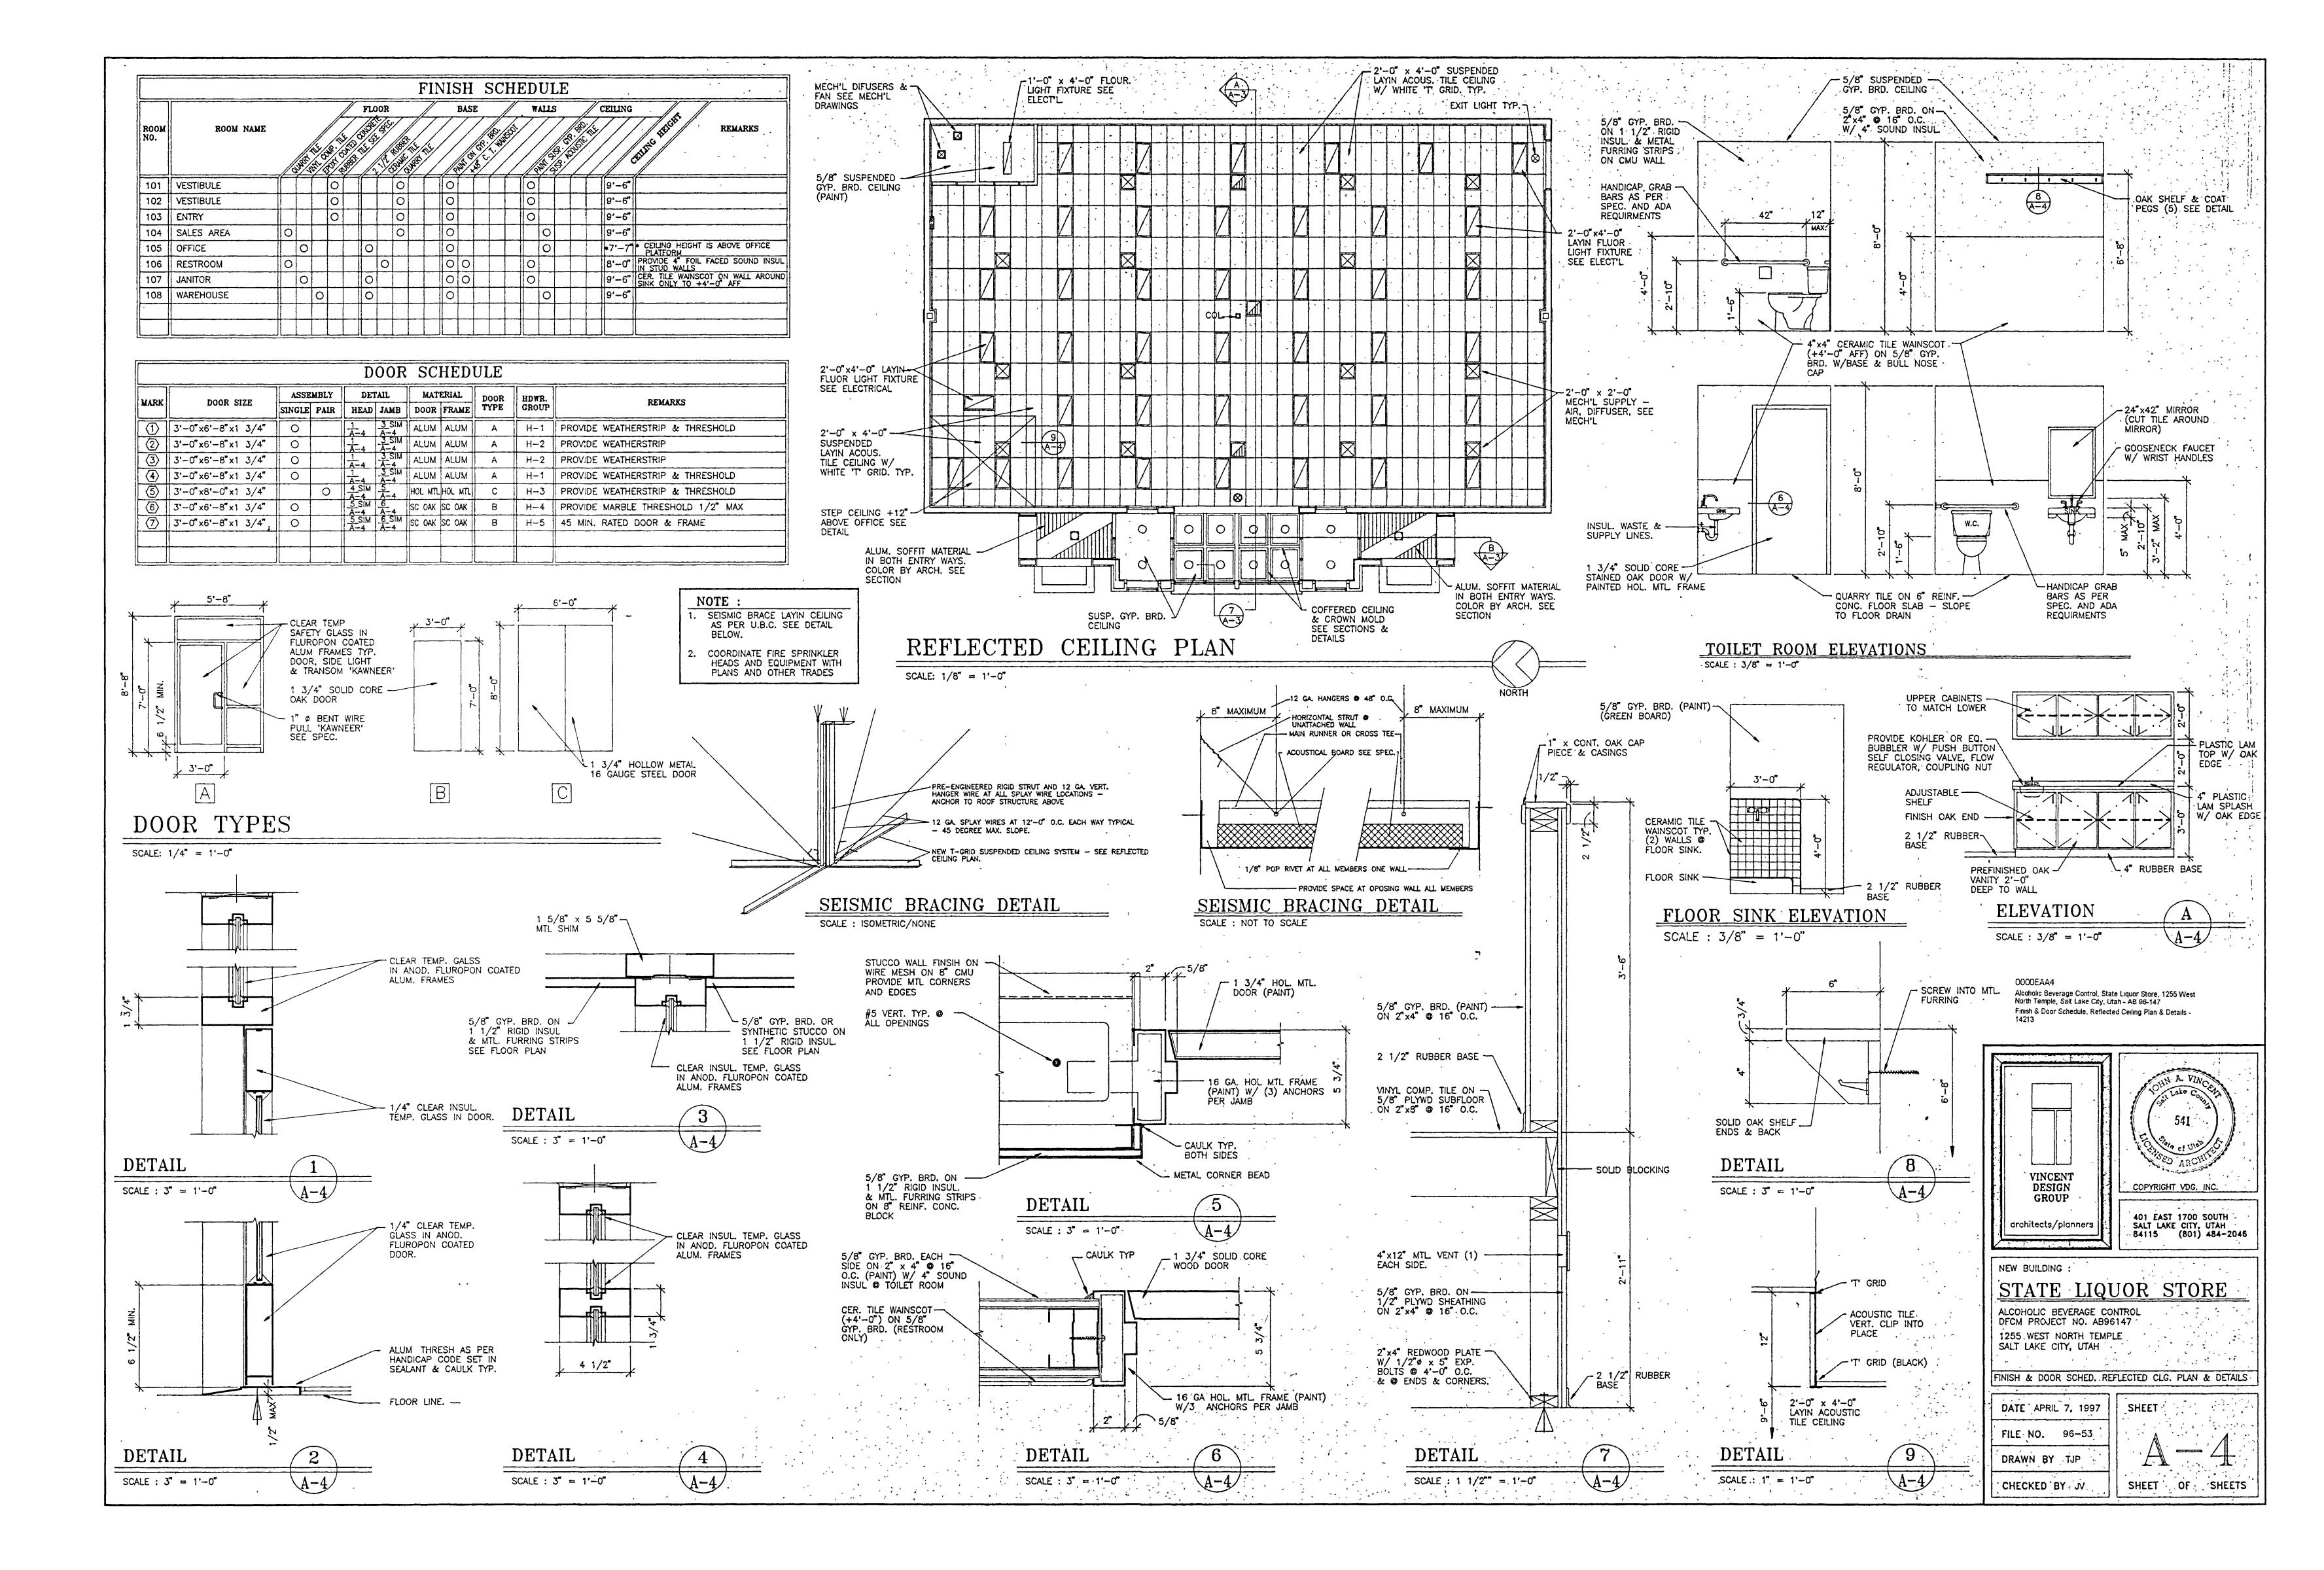

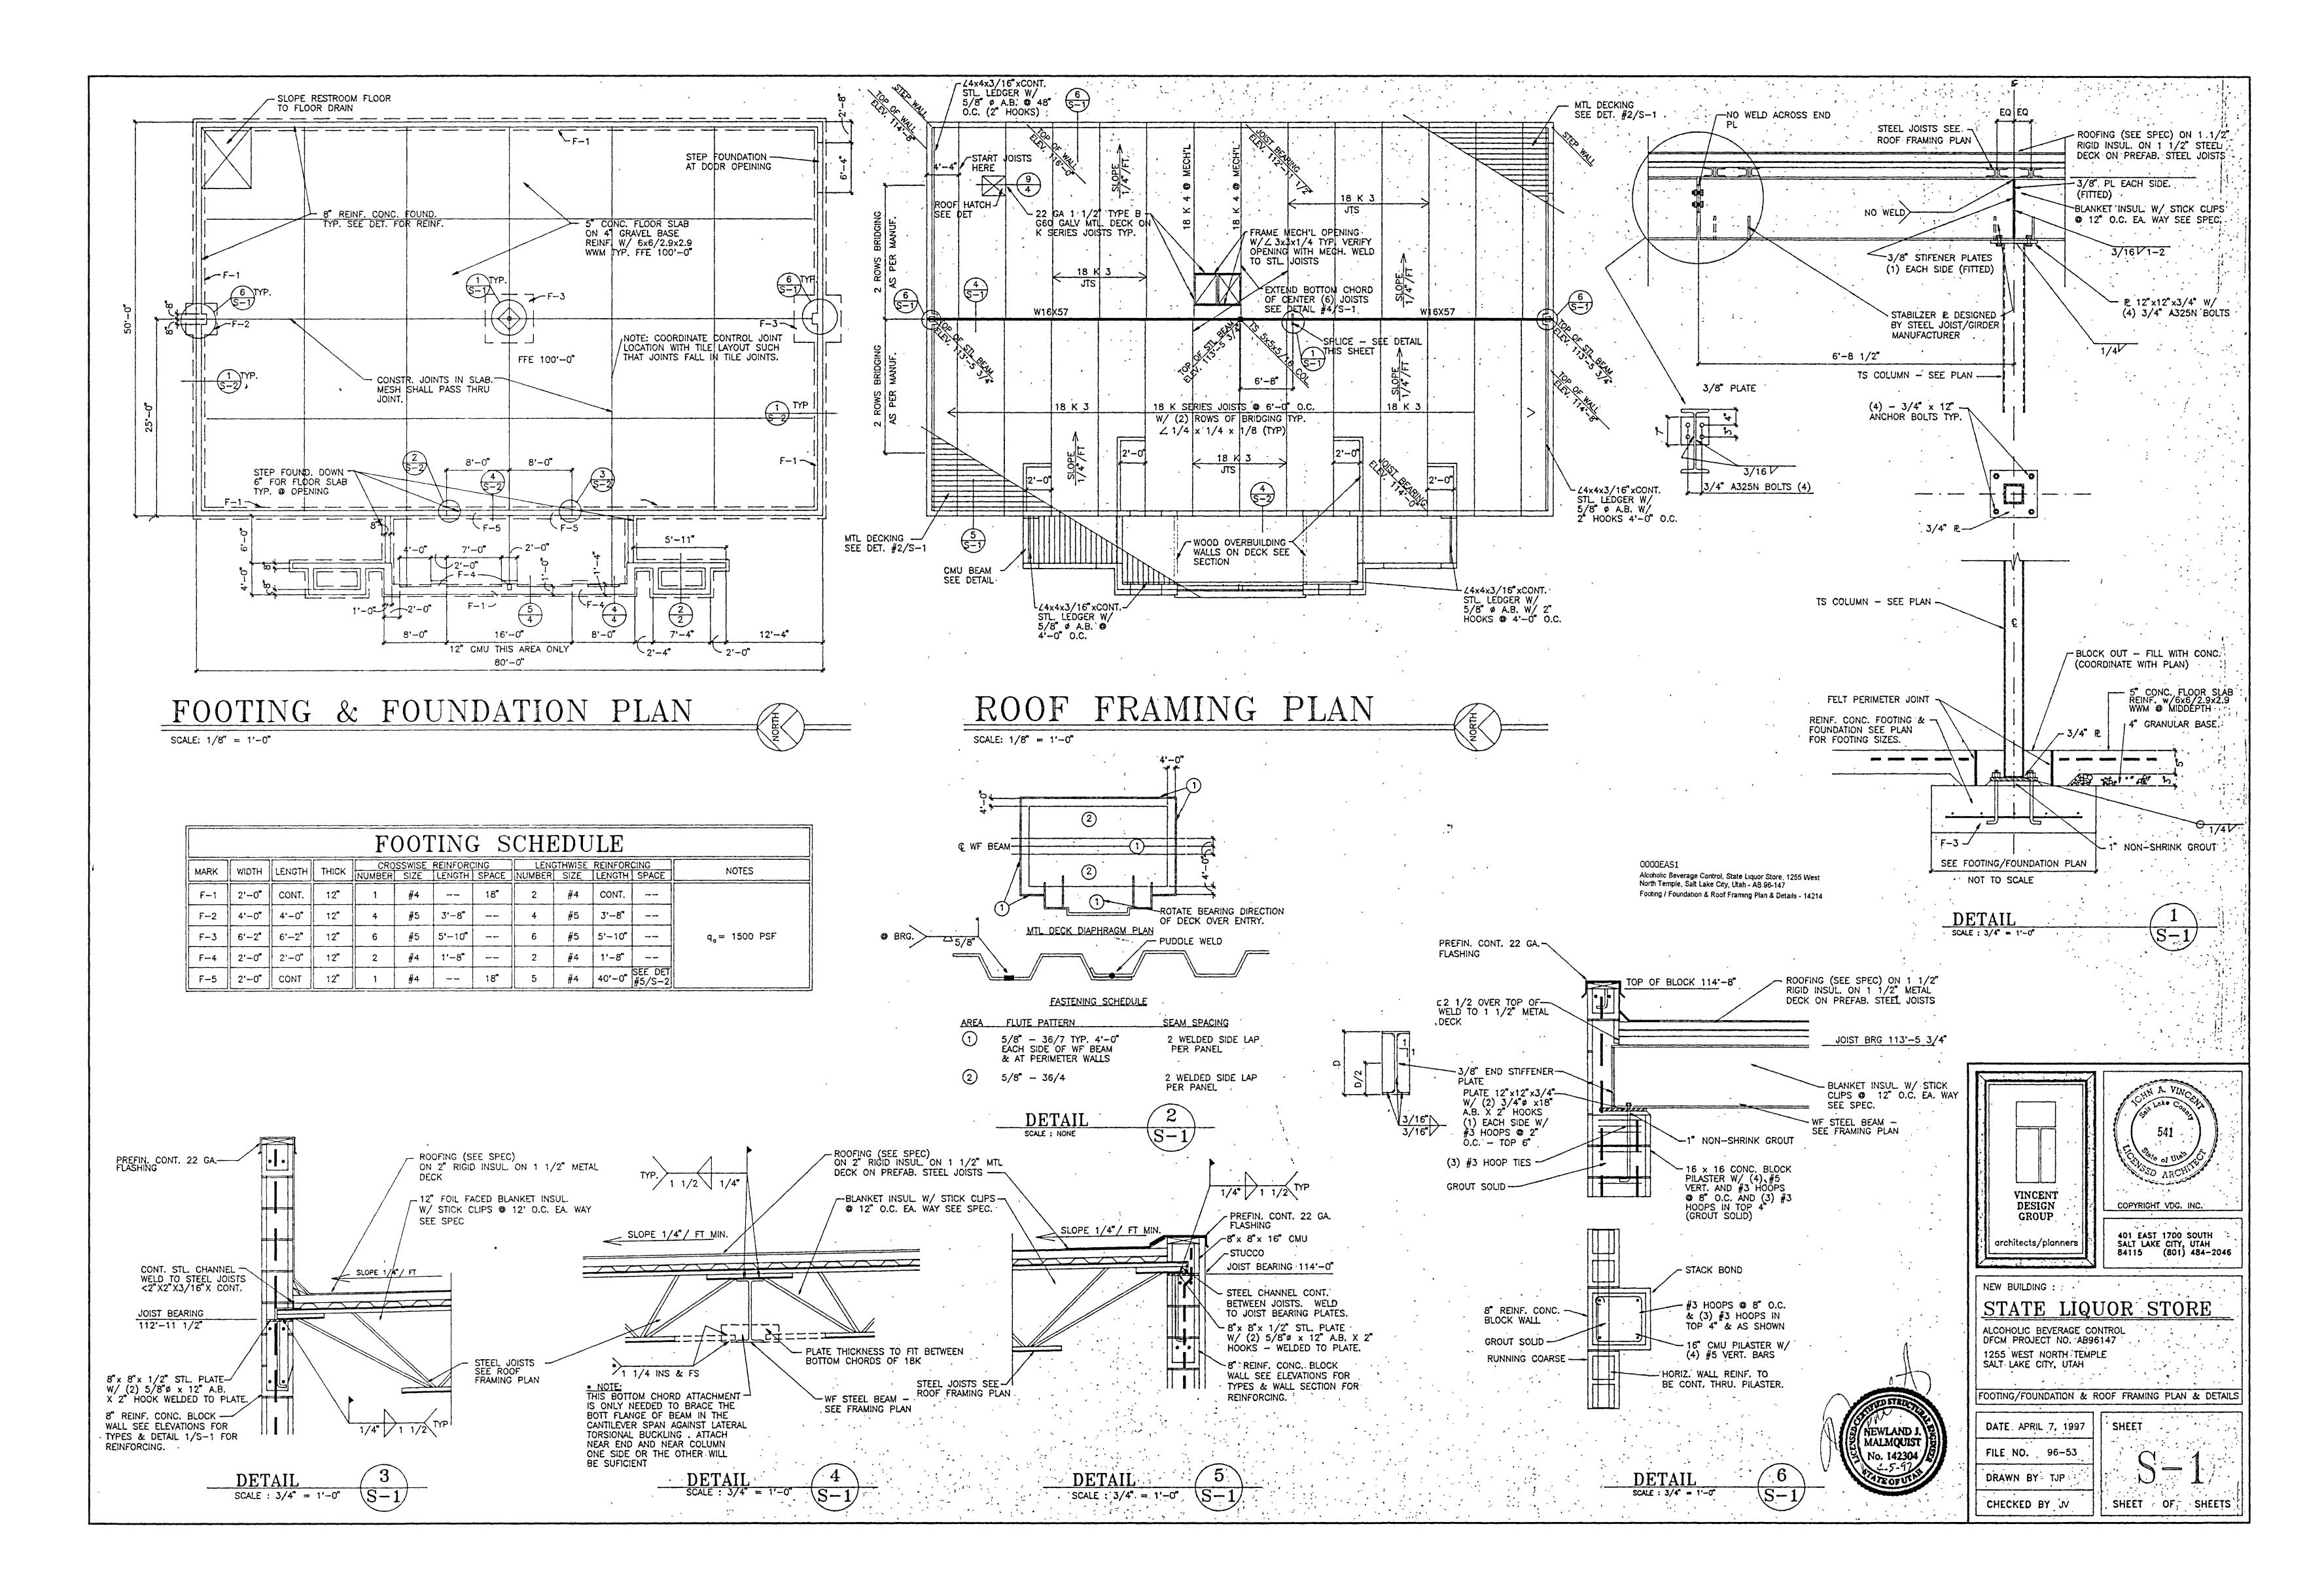



STRUCTURAL NOTES:

- - THE CONTRACTOR SHALL VERIFY ALL DIMENSIONS & CHECK CONDITIONS AT THE SITE BEFORE STARTING WORK AND SHALL IMMEDIATELY NOTIFY THE ARCHITECT AND ENGINEER OF ANY DISCREPANCIES.
- 2. TYPICAL DETAILS SHALL APPLY IN GENERAL CONSTRUCTION UNLESS SPECIFICALLY DETAILED. WHERE NO DETAILS ARE GIVEN, CONSTRUCTION WILL BE AS FOR SIMILAR WORK. DO NOT SCALE DRAWINGS.
- ALL DESIGN AND WORKMANSHIP SHALL CONFORM TO THE REQUIREMENT OF THE 1994 UNIFORM BUILDING CODE (UBC). ALL APPLICABLE MATERIAL STANDARDS SHALL BE THE MOST RECENT EDITION.
- 4. ANY OMISSIONS OR CONFLICTS BETWEEN THE VARIOUS ELEMENTS OF THE WORKING DRAWINGS AND/OR SPECIFICATIONS SHALL BE BROUGHT TO THE ATTENTION OF THE ARCHITECT AND ENGINEER BEFORE PROCEEDING WITH ANY WORK SO INVOLVED.
- 5. BRACING AND SHORING CONTRACTOR IS SOLELY RESPONSIBLE FOR JOBSITE SAFETY AND SHALL PROVIDE AND MAINTAIN ADEQUATE BRACING AND SHORING AT ALL TIMES DURING CONSTRUCTION.
- 6. DESIGN LOADS
 - GRAVITY LIVE LOADS:
 - SEISMIC FORCES ARE CALCULATED ON BASIS OF SHEAR WALLS TAKING 100% OF LATERAL LOAD FOR UBC ZONE 3 REQUIREMENTS. PARAMETERS ASSIGNED: RW=6.
- REFER TO REPORT BY DELTA GEOTECHNICAL CONSULTANTS OF AUGUST 1996. INCORPORATE RECOMMENDATIONS INTO BID.
- 2. FOOTING TYPE SPREAD. ALLOWABLE BEARING OF 1500 PSF. NO PIPESUNDER FOOTINGS UNLESS APPROVED BY ENGINEER.
- CONCRETE:
- NORMAL WEIGHT CONCRETE (145 PCF MIN.) SHALL HAVE A MINIMUM 28 DAY CYLINDER STRENGTH OF 3000 PSI FOR FOOTINGS AND WALLS. USE 4000 PSI FOR EXTERIOR AND INTERIOR GRADE SLABS. USE ASTM C150 TYPE: 'II' PORTLAND CEMENT.
- 2. ALL CONCRETE SHALL BE TESTED IN ACCORDANCE WITH UBC STD. NO. 26-10 WITH REPORTS FILED WITH ARCHITECT AND ENGINEER.
- 3. ALL REINFORCING STEEL, DOWELS AND ANCHOR BOLTS AND OTHER INSERTS OR EMBEDDED ITEMS SHALL BE FIRMLY SECURED IN POSITION PRIOR TO PLACING


CONCRETE. ANCHOR BOLTS SHALL CONFORM TO ASTM A-307.


- 4. SPECIAL ATTENTION SHALL BE PAID IN THE PREPARATION OF SUBGRADE, FORMING, PLACING AND JOINING OF THE STORAGE SLAB TO MINIMIZE SETTLEMENTS AND CRACKING.
- 1. REINFORCING STEEL SHALL BE DEFORMED AND CONFORM TO ASTM A615 GRADE 60 FOR ALL MAIN REINFORCING. TIES, STIRRUPS, AND HOOPS SHALL CONFORM TO GRADE 60. WELDED ANCHORS SHALL CONFORM TO ASTM A496. WELDING SHALL CONFORM TO UBC STD. 26-8. FABRICATE AND PLACE REINFORCING IN ACCORDANCE WITH UBC SEC. 2607.
- 2. REINFORCING SHALL HAVE THE FOLLOWING COVER UNLESS OTHERWISE NOTED: CONCRETE AGAINST EARTH (NOT FORMED): CONCRETE AGAINST EARTH (FORMED:
- 3. REINFORCING STEEL NOTED "CONTINUOUS" MAY BE SPLICED WITH A LAP OF 40 BAR DIAMETERS UNLESS NOTED OTHERWISE. SPLICES SHALL NOT BE MADE IN REGIONS OF HIGH STRESS UNLESS SPLICE LENGTHS ARE INCREASED ACCORDING TO CODE.
- 4. EXTEND ALL REINFORCING AROUND CORNERS OR FURNISH CORNER BARS. PROVIDE HOOKS AT WALL TERMINATIONS OR INTERSECTIONS.
- 1. ALL WOOD FRAMING SHALL CONFORM TO UBC STD. NO. 25-4 AS FOLLOWS: JOINTS AND LINTELS NO. 2 DF/LARCH LIGHT FRAMING NO. 2 DF/LARCH
- 2. SILL PLATES ON CONCRETE OR MASONRY SHALL BE TREATED AND ANCHORED WITH 5/8 DIAMETERS BOLTS AT 4 FEET ON CENTER UNLESS NOTED OTHERWISE (UNO).
- 3. NAILING SHALL CONFORM TO UBC TABLE 25-Q UNO.
- BOLTS, CLIPS, HOLD-DOWNS AND MISCELLANEOUS CONNECTORS SHALL BE AS SHOWN OR NOTED OR AS REQUIRED BY CODE FOR SEISMIC OR WIND LOADING ON WOOD FRAMED STRUCTURES. ALL SERIALIZED METAL CONNECTORS SHALL BE SIMPSON OR
- 5. PLYWOOD SHALL CONFORM TO UBC STD. 25-9 CDX THICKNESS AS NOTED. PARTICLE BOARD SHALL CONFORM TO UBC STD. NO. 25-25.
- STEEL JOISTS:
- 1. STEEL JOISTS SHALL BE OPEN WEB TYPE AS INDICATED AND IN COMPLIANCE WITH THE STEEL JOIST INSTITUTE (SJI) STANDARDS FOR MATERIALS, DESIGN AND MANUFACTURING. CONFORM TO SJI REQUIREMENTS FOR MATERIALS APPLICATION, HANDLING AND ERECTION.
- STEEL FLOOR AND ROOF DECK SHALL CONFORM TO SDI SPECIFICATIONS FOR MATERIALS, APPLICATION, DESIGN, MANUFACTURING, HANDLING AND ERECTION.
- 2. ANCHORAGE OF DECK TO SUPPORTING MEMBERS SHALL BE MADE WITH WELDS PLACED AT RIBS AS SHOWN AND SIDE LAPS BETWEEN DECK SECTIONS SHALL BE MADE WITH WELDED SEAMS AS SHOWN AND NOTED.
- MISCELLANEOUS STRUCTURAL STEEL:
- CONFORM TO ASTM A36 FOR ALL ROLLED SHAPES, BARS AND PLATES, A53 GRADE B FOR PIPE AND A500 GRADE B FOR STRUCTURAL TUBES.
- 2. ALL BOLTED CONNECTIONS SHALL BE MADE WITH BOLTS CONFORMING TO ASTM A307 GRADE B FOR LIGHT FABRICATIONS, STEEL TO WOOD, MASONRY OR CONCRETE CONNECTION AND TO A325N FOR STEEL TO STEEL CONNECTIONS. PROVIDE WASHERS OR BEARING PLATES WHERE BOLTS BEAR AGAINST WOOD OR MASONRY.
- 3. ALL WELDING RODS SHALL CONFORM TO AWS A5.1 E70XX LOW HYDROGEN AND WORKMANSHIP SHALL CONFORM TO AWS D1.1 SPECIFICATIONS. WELDER PERSONNEL SHALL HAVE A CURRENT AWS CERTIFICATION.
- 1. CONFORM TO UBC CHAPTER 24. FM = 1500 PSI.
- 2. SPECIAL INSPECTION PER UBC 1994.
- 3. MASONRY UNITS SHALL BE LIGHT WEIGHT CONCRETE CONFORMING TO ASTM C90 GRANDE N.
- 4. MORTAR SHALL BE TYPE S, 1800 PSI MINIMUM COMPRESSIVE STRENGTH.
- 5. REINFORCING SHALL CONFORM TO ASTM A615 GRADE 60.
- 6. GROUT SHALL HAVE A MINIMUM COMPRESSIVE STRENGTH OF 2000 PSI. LOW LIFT GROUTING IS THE PREFERRED METHOD.
- 7. ANCHOR BOLTS SHALL BE EMBEDDED A MINIMUM OF 5-1/2 INCHES INTO GROUTED CORES OR BOND BEAMS FOR HORIZONTAL BOLTS AND 12" FOR VERTICAL BOLTS.
- 8. REINFORCING SHALL BE LAPPED A MINIMUM OF 40 DIAMETERS UNLESS NOTED
- OTHERWISE.
- 9. ARCHITECT SHALL VISUALLY OBSERVE ALL PLACEMENT OF REBAR PRIOR TO GROUTING OPERATIONS.

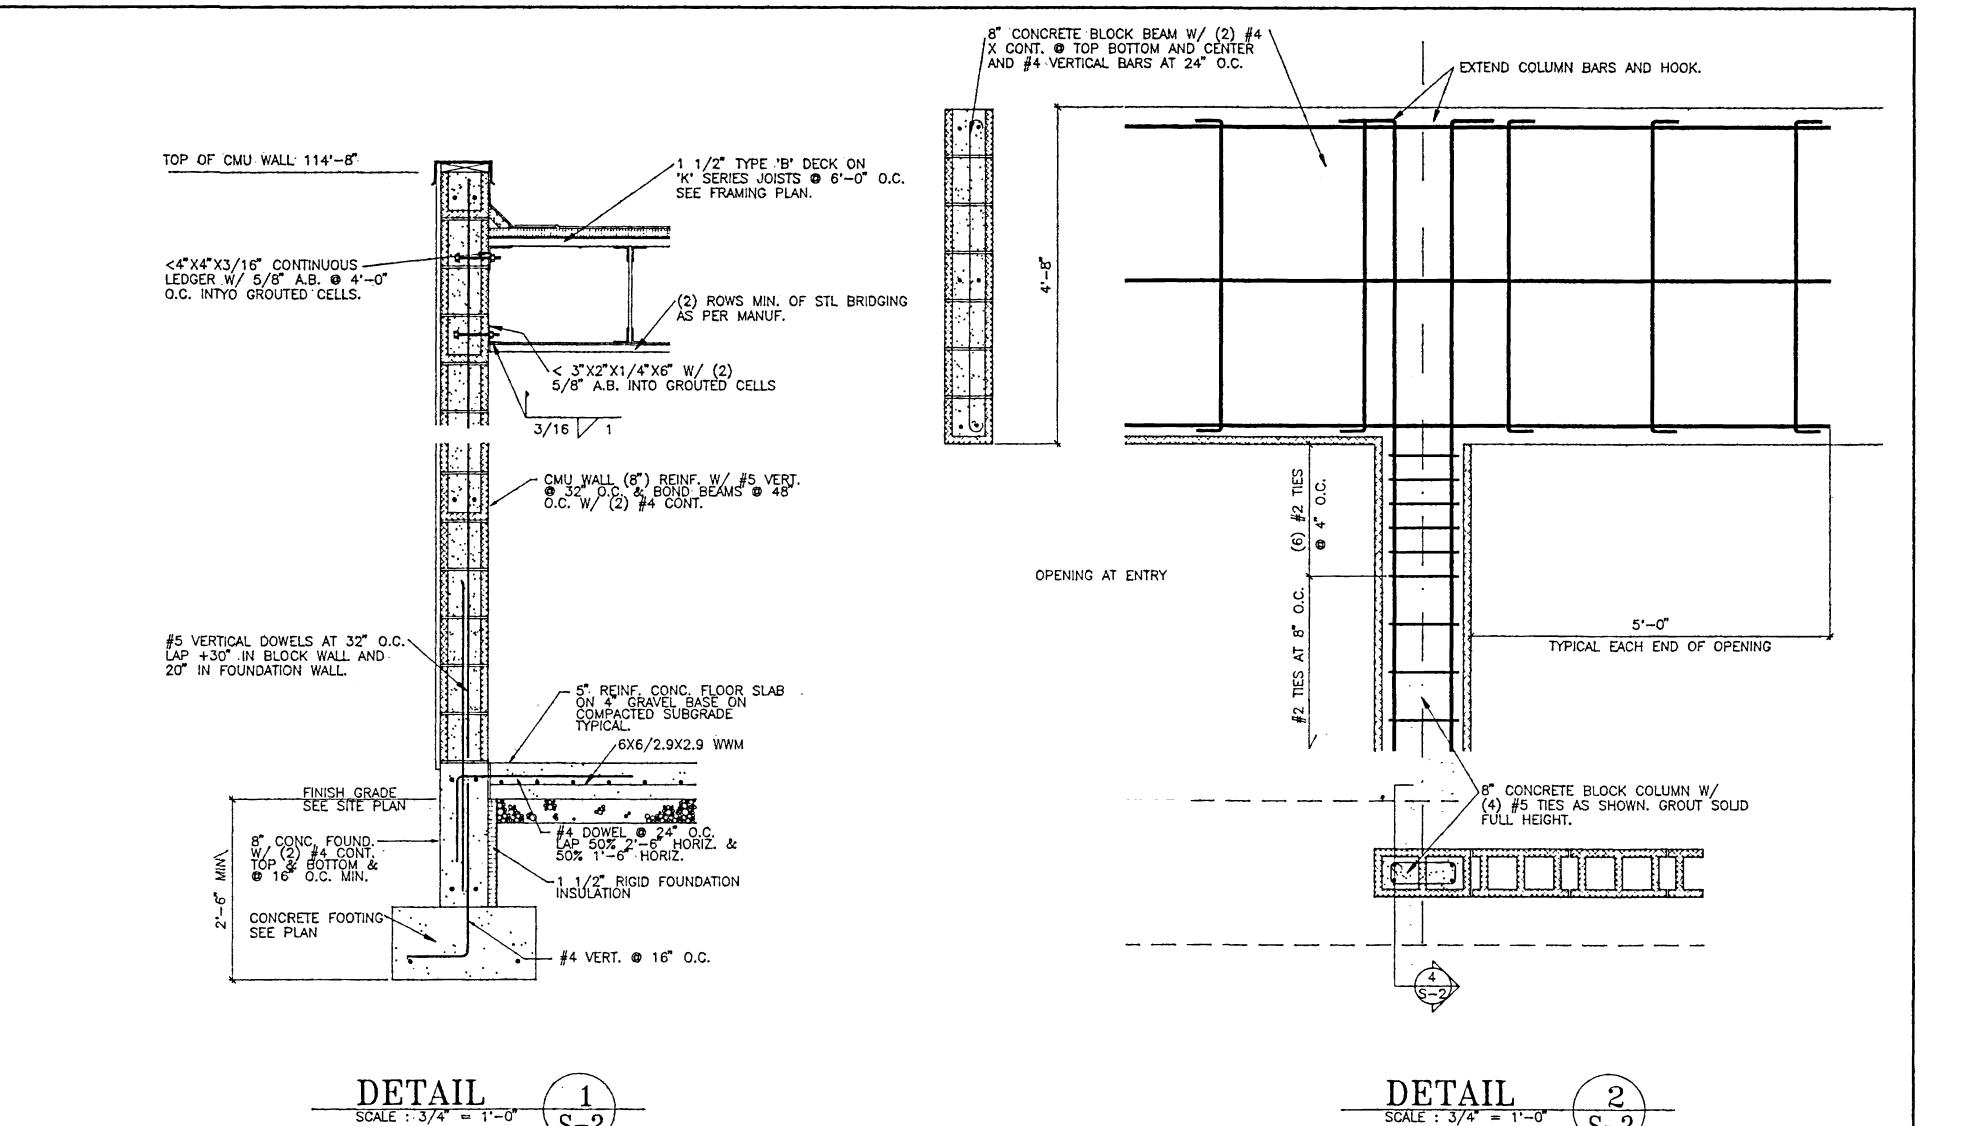


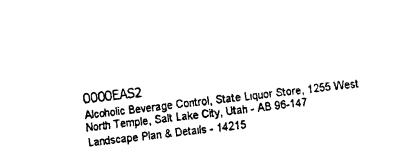





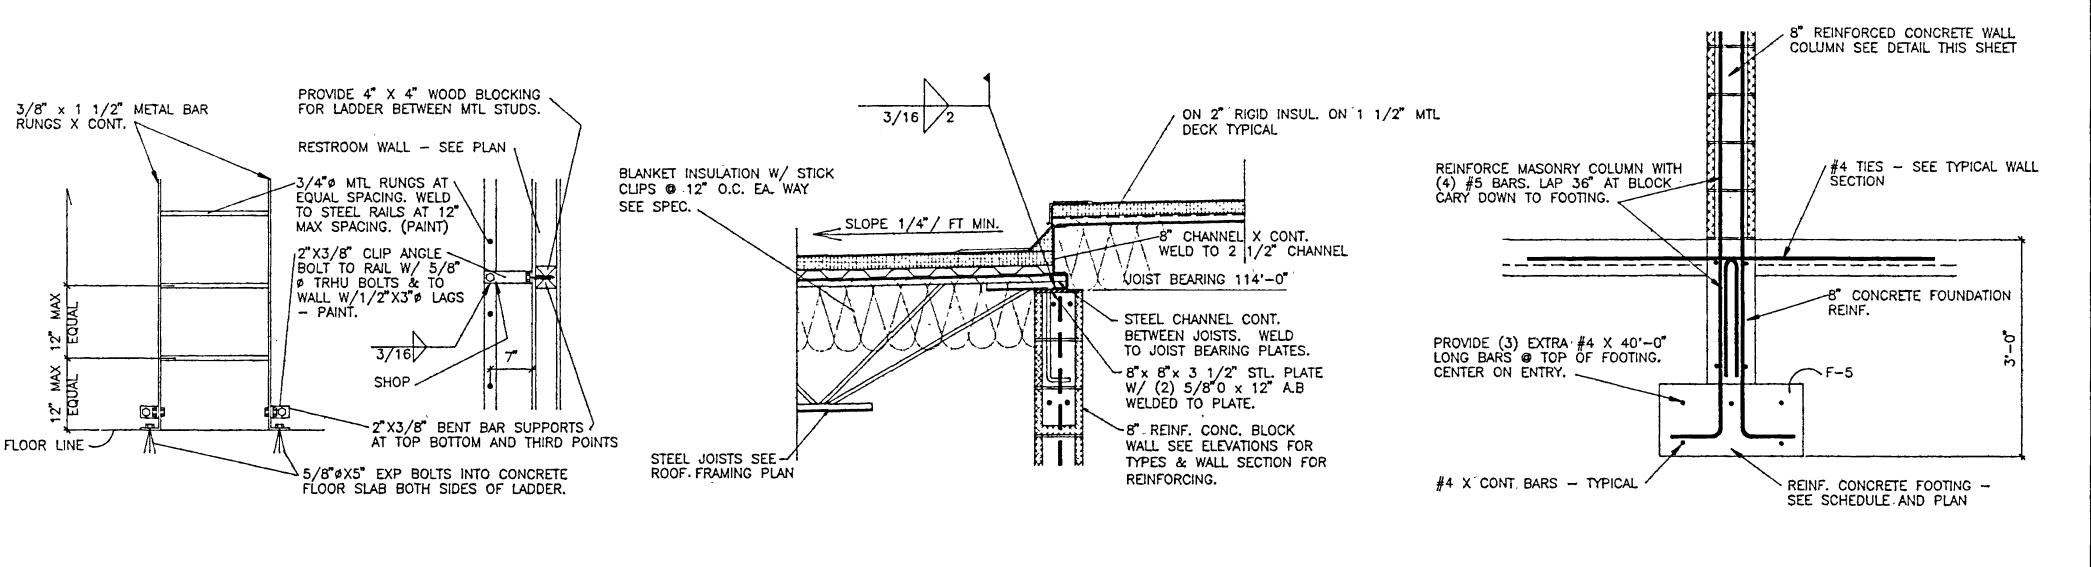


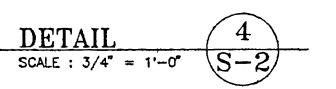

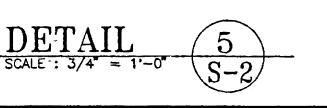

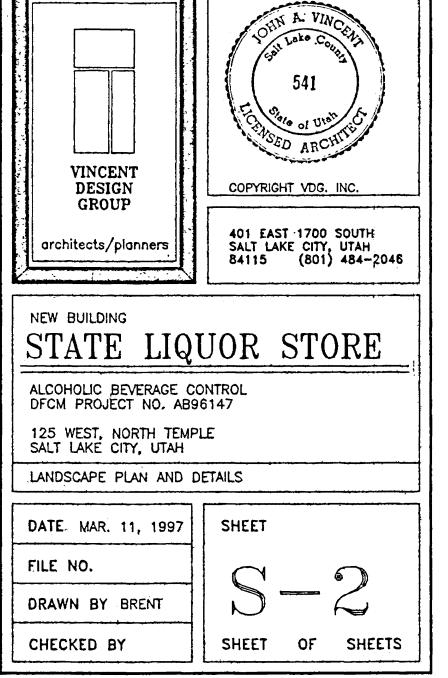

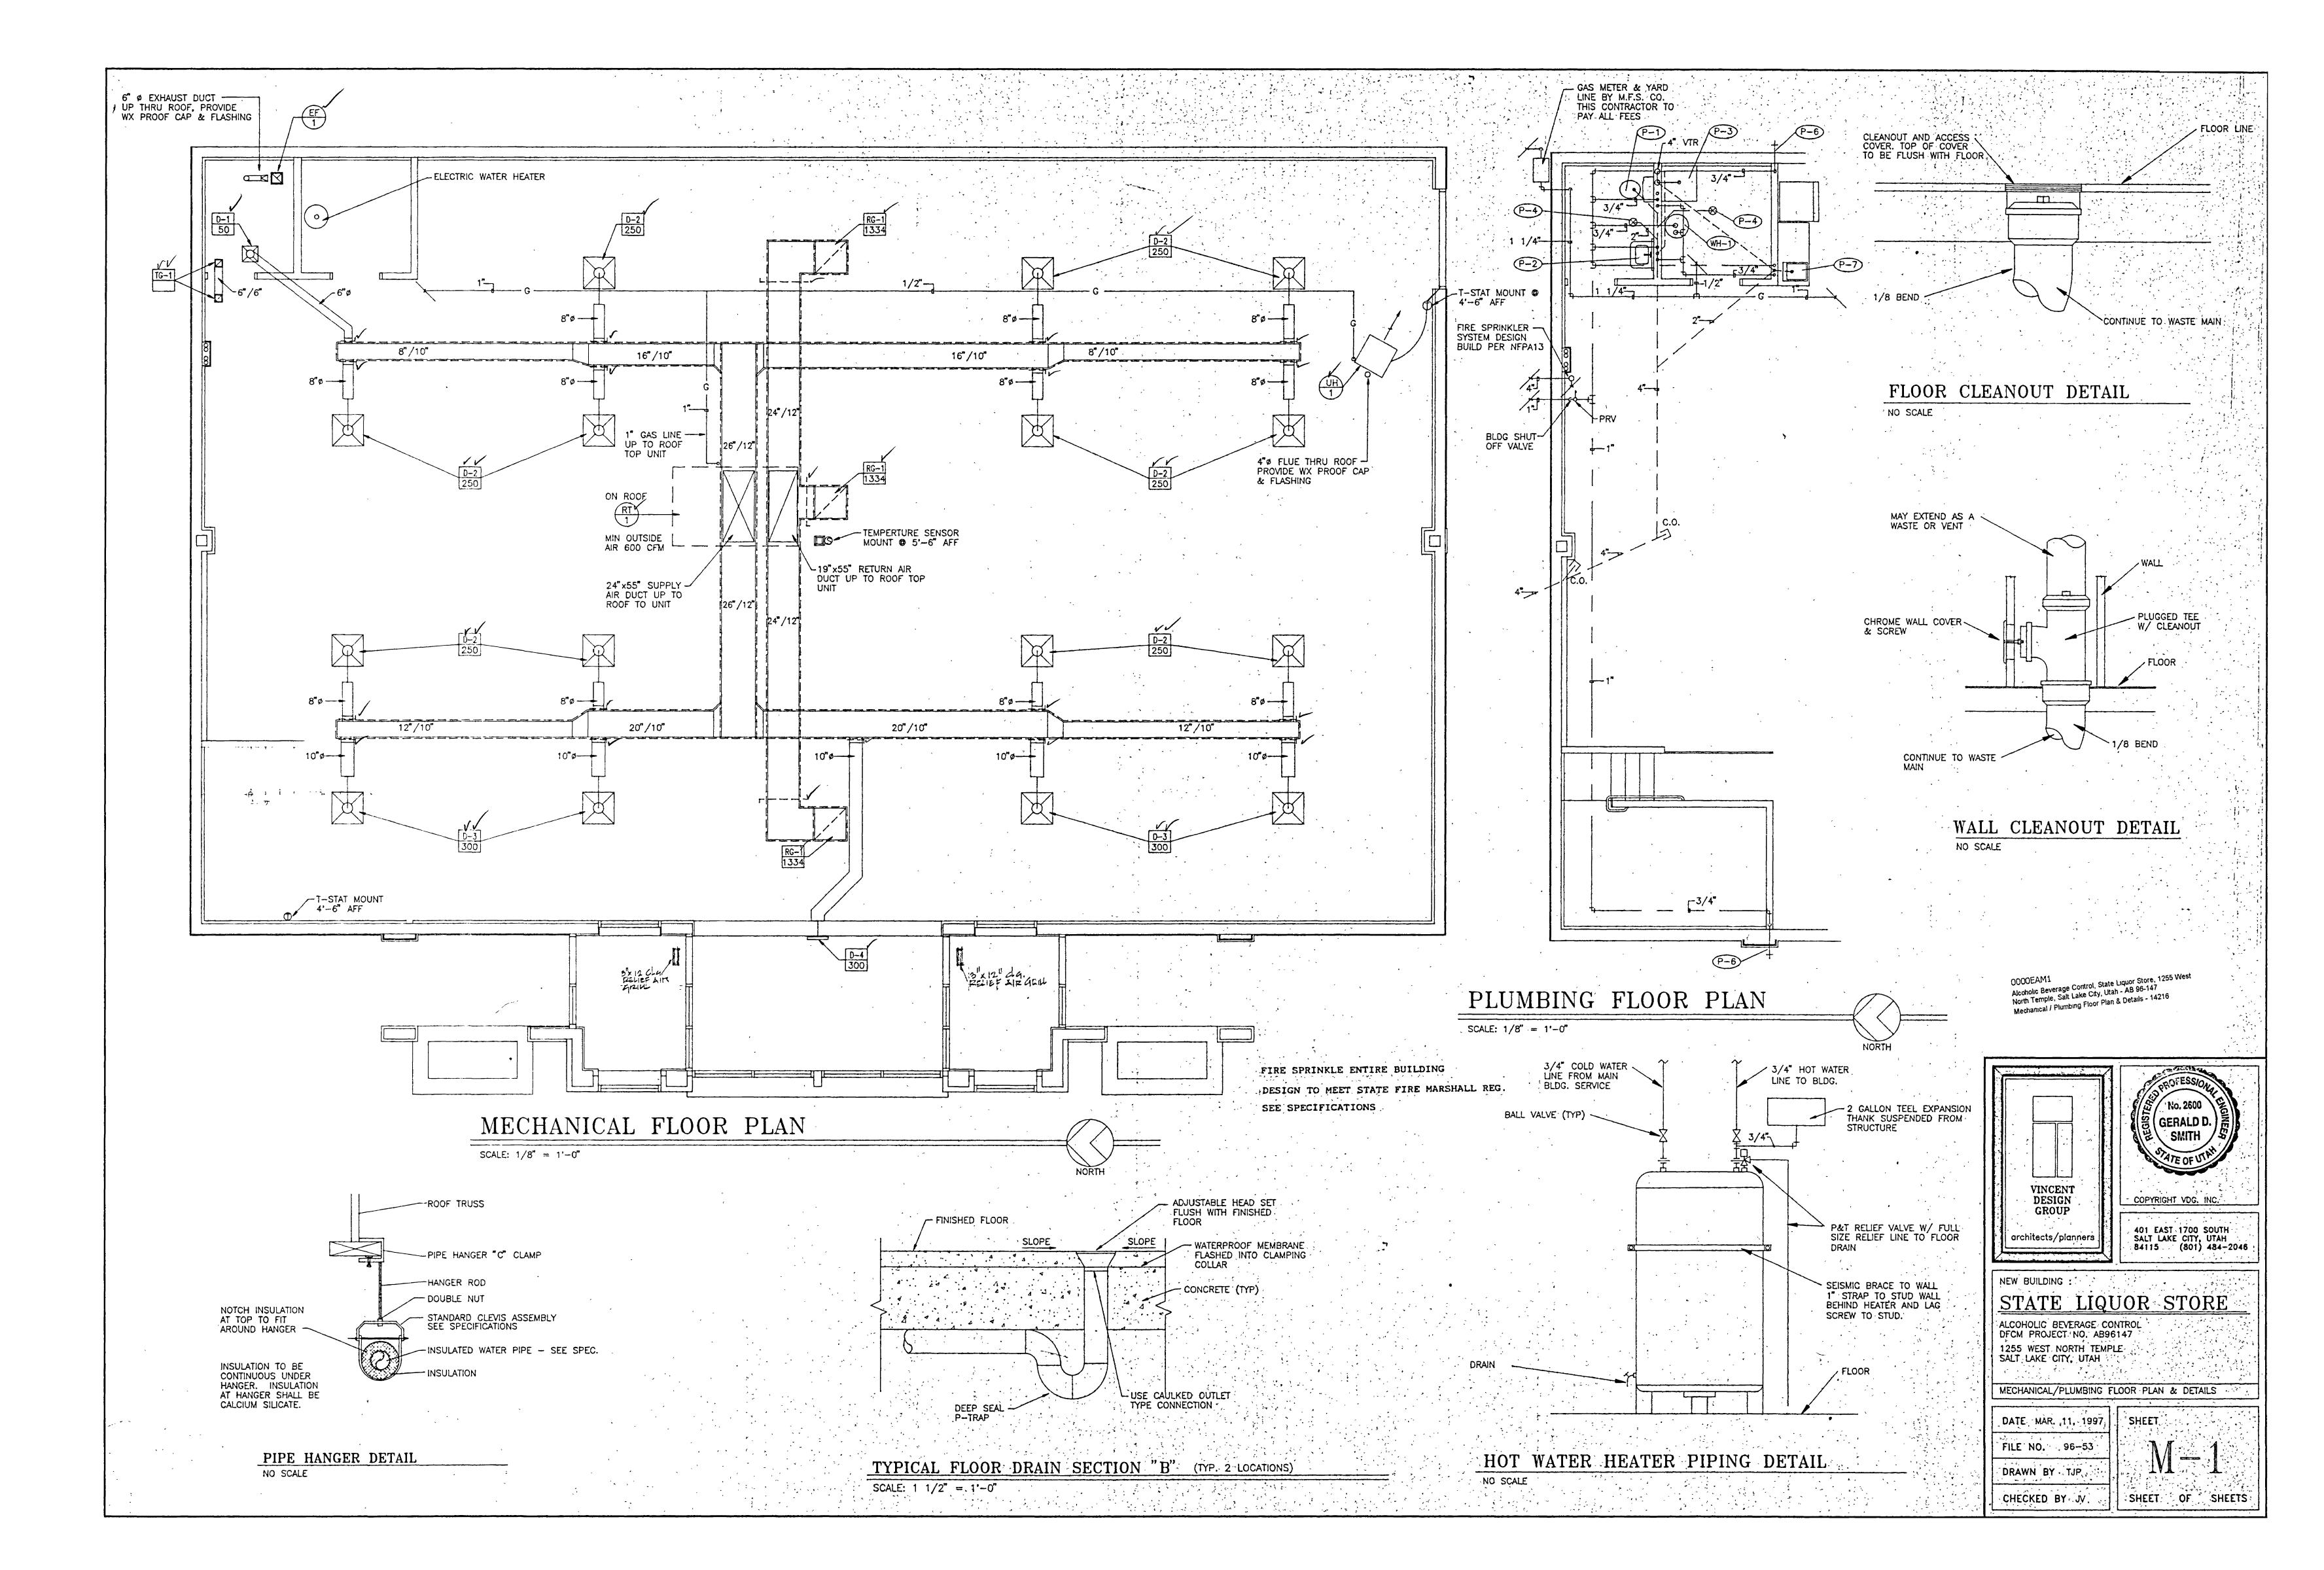

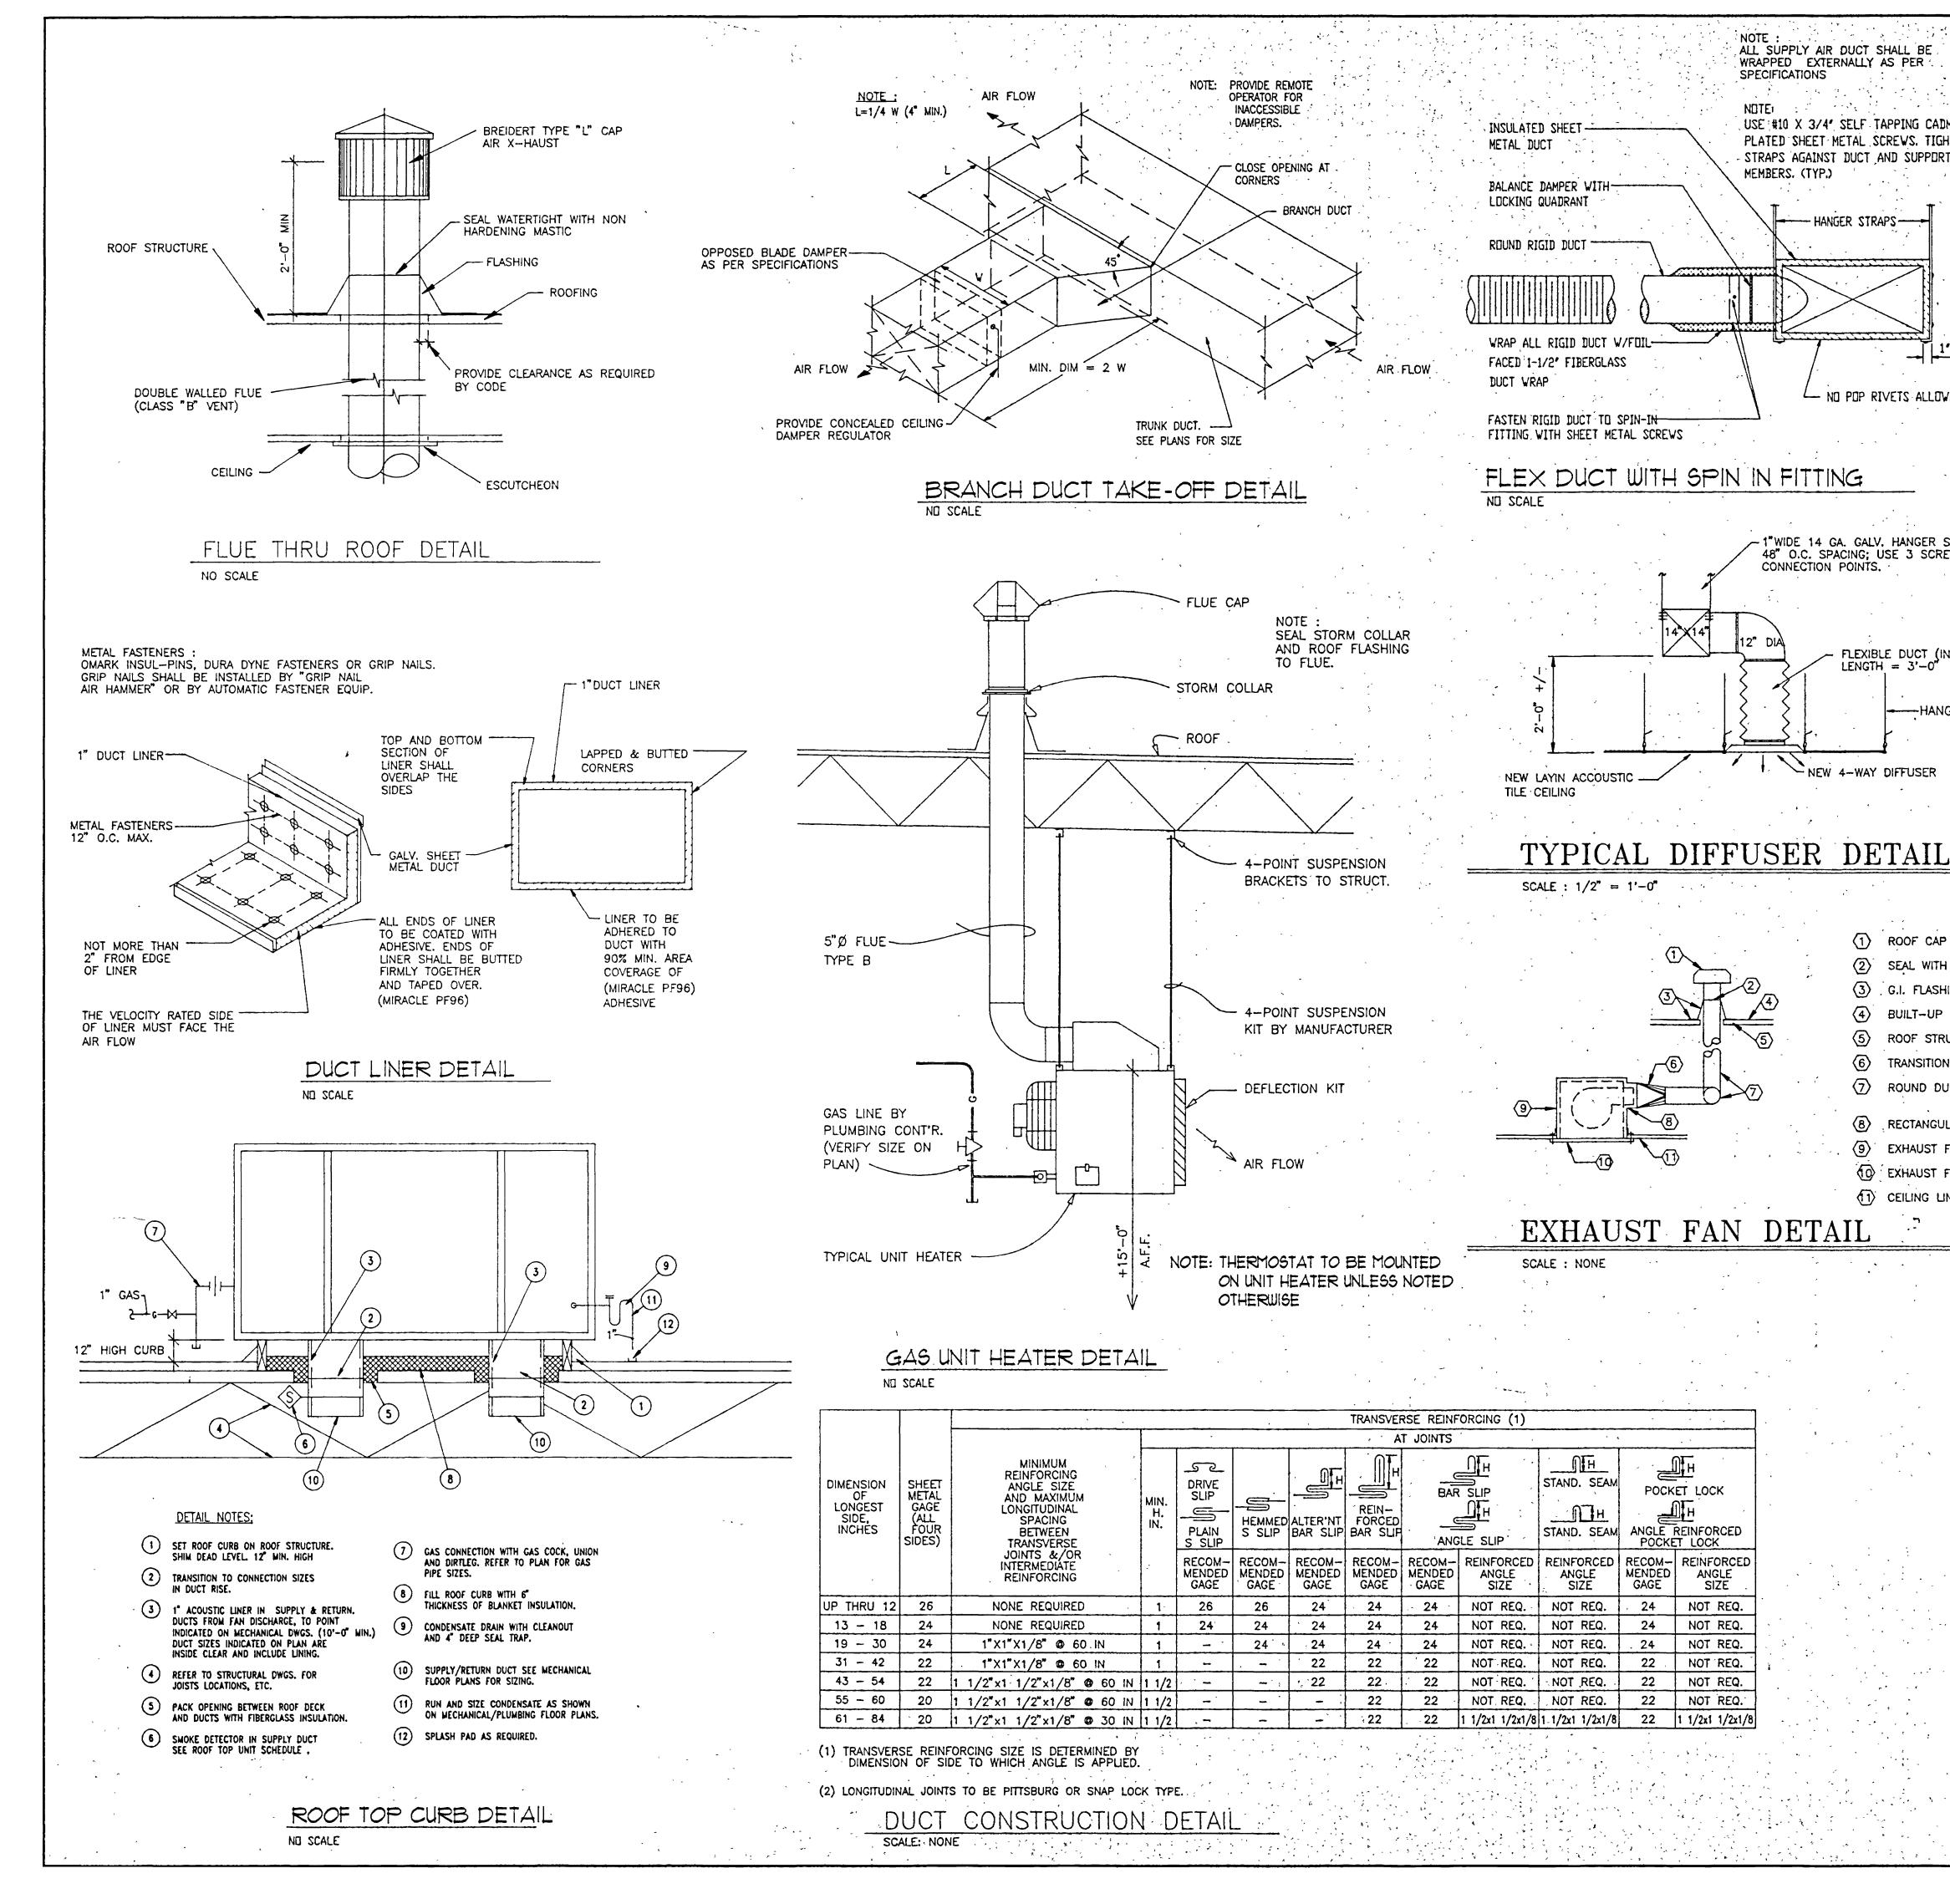

SPECIFICATIONS USE #10 X 3/4" SELF TAPPING CADMIUM INSULATED SHEET-PLATED SHEET METAL SCREVS. TIGHTEN AL - STRAPS AGAINST DUCT AND SUPPORT MEMBERS. (TYP.) BALANCE DAMPER WITH-LOCKING QUADRANT ROD - HANGER STRAPS ROUND RIGID DUCT ROD WRAP ALL RIGID DUCT W/FUIL-FACED 1-1/2' FIBERGLASS - NO POP RIVETS ALLOWED FASTEN RIGID DUCT TO SPIN-IN-

- 1"WIDE 14 GA. GALV. HANGER STRAPS AT 48" O.C. SPACING; USE 3 SCREWS AT ALL CONNECTION POINTS.

FLEXIBLE DUCT (INSULATED) MAXIMUM LENGTH = 3'-0"

1) ROOF CAP FOR FLAT ROOF

(3) G.I. FLASHING COLLAR

(8) RECTANGULAR OUTLET

(D) EXHAUST FAN OUTLET

4 BUILT-UP ROOF

(5) ROOF STRUCTURE

6 TRANSITION

(9) EXHAUST FAN

(1) CEILING LINE

(2) SEAL WITH WATERPROOF CAULKING

7 ROUND DUCT (ROUTE AS SHOWN

-HANGER WIRES, AS REQUIRED

ALL SUPPLY AIR DUCT SHALL BE

WRAPPED EXTERNALLY AS PER

"大学"的"

FLEX DUCT WITH SPIN IN FITTING

POCKET LOCK

ANGLE REINFORCED

NOT REQ.

NOT REQ.

NOT REQ.

NOT REQ.


POCKET LOCK

22 .

HANGER SIZES FOR REGISTER AND GRILLE SCHEDULE RECTANGULAR DUCT C.F.M. RANGE SYMBOL SIZE COMMENTS 30" 1" x18" GAGE | NONE REQUIRED | 10'-0" · RG-1 22"x22" RETURN 1334 TITUS TXP 24"x24" TG-1 6"x6" TRANSFER TITUS 25-RL5 36" 1/4" ROUND 1 1/2"x1 1/2"x1/2" 8'-0" DIFFUSER SCHEDULE 48" 1/4" ROUND 2"x2"x1/8" 8'-0" SYMBOL SIZE BLOW TYPE C.F.M. RANGE COMMENTS 60" 3/16" ROUND 2"x2"x1/8" 8'-0" D-1 6" & 3 WAY SUPPLY TITUS TMS 12" x 12" D-2 8"ø 4 WAY SUPPLY -TITUS TMS 24" x 24". 84" 3/8" ROUND 2"x2"x1/8" 8'-0" D-3 10"ø 4 WAY SUPPLY TITUS TMS 24" x 24" D-4 10"0 3 WAY SUPPLY WALL MOUNT 8" x 16

	ROOFTOP HEATING COOLING UNIT																					
UNIT NO.	CFM	EXT S.P.	COOLING MBH		HEAT OUTPUT MBH	UNIT WEIGHT	С	OMP	EL RESS		Τ	~	ARACTE R FAN	T		FAN	MIN CIR AMP	MAX FUSE AMP	ELE FUSE	VOLTS	0	HZ
				1	①		#	HP	HLA	LRA	#	HP	FLA	#	HP	FLA		,	SIZE	. ,		, ; ;
RT-	1 4000	1.00"	- 125	205	160		2	3.5	18.0	118	1	1.0	5.5	1	2.0	7.6	55.7	70		208	3	60)

NOTES: (1) AT SEA LEVEL (2) TRANE MODEL NO. YCD120C3M4AWL, EER 9.0 EFF RATING AFUE 80%

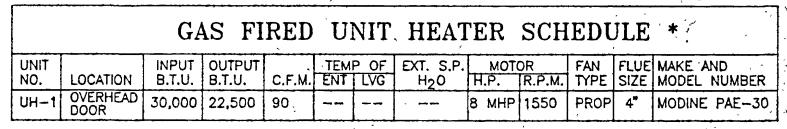


* EFF RATING : AFUE 80%


SYMBOL	NO. REQ'D	LBS. WT.	LOCATION	C.F.M.	TOTAL S.P.	R.P.M.	MOTOR	ROOF OF WALL OPENING	COMMENTS
EF-1	1 .	21	RESTROOM	90 ', ″	.125	1050	50 WATTS 120/1/60	CEILING MOUNT	PENN ZEPHYR MODEL NO. Z-6 c/w ROOF CAP

		PLU	MBIN	G FIX	TURE	SCH	EDUL	E
LEGEND	SYMBOL	FIXTURE	WASTE	VENT	TRAP	c.w.	H.W.	COMMENTS
P-1 .	O []	WATER CLOSET	4*	2"	4"	1/2"		
P-2	Œ	HAND SINK	1 1/2"	1 1/2"	1 1/2"	1/2"	1/2";	
P-3		SERVICE SINK	2*	. 1 1/2"	2"	1/2"	1/2"	FLOOR TYPE
. P-4	8	FLOOR DRAIN	3"	1 1/2"	3"	~~~		
P-5	,	NOT USED) 	NOT USED
P-6	+	HOSE BIBB			1000	3/4"		FREEZE-PROOF
P-7	Q	BREAK SINK	1 1/2"	1 1/2"	1 1/2"	1/2"	1/2"	W/ WATER SPOUT FOR DRINKING WATER
WH-1	·	WATER HEATER				3/4*	3/4"	ELECTRIC INPUT 20 GAL

1 WATER HEATER MUST MEET REQUIREMENTS OF ENERGY CODE AND SUPPLY TEMPERATURE TO BE SET AT 105° F. MIN. EFF.

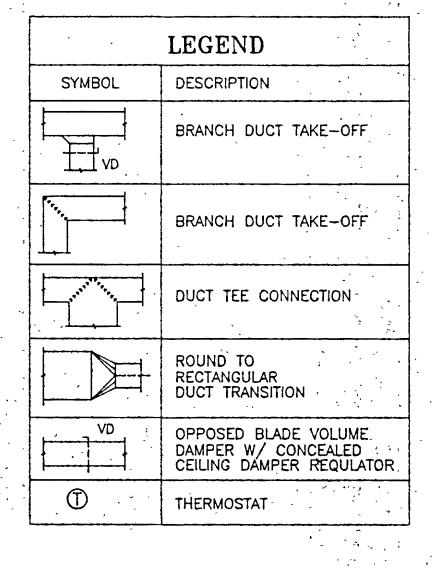


0000EAM2 Alcoholic Beverage Control; State Liquor Store, 1255 West North Temple, Salt Lake City, Utah - AB 96-147 Mechanical Details & Schedules - 14217

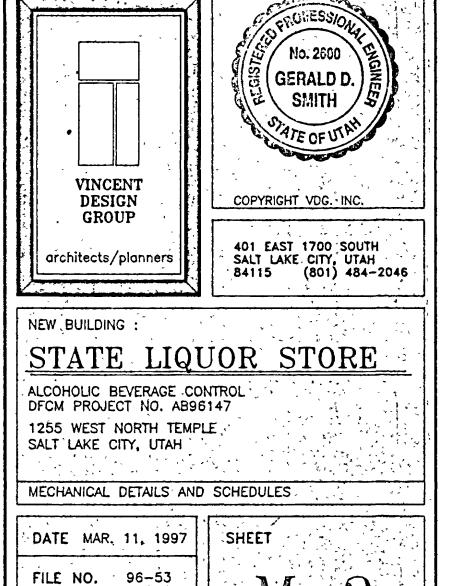



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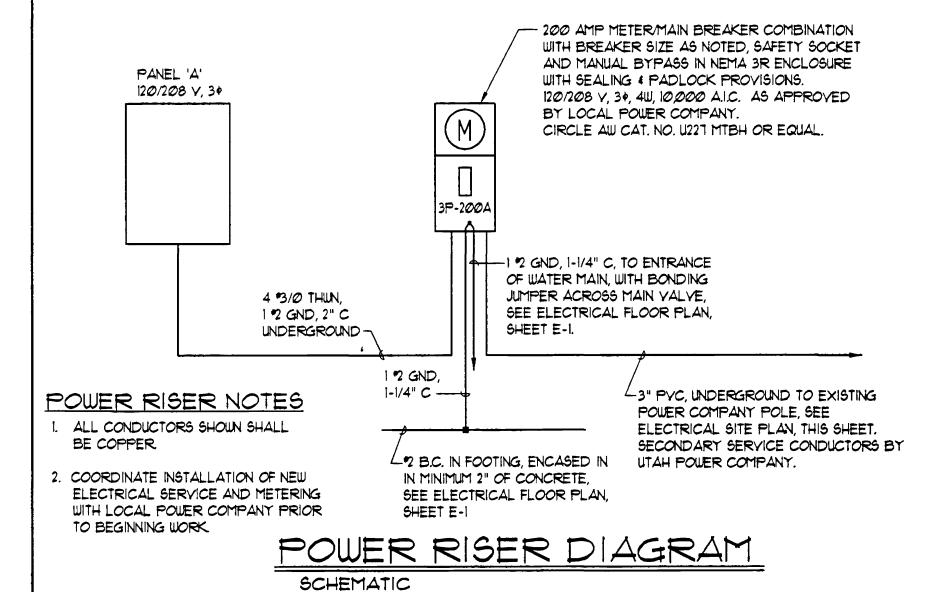
CHECKED BY JV





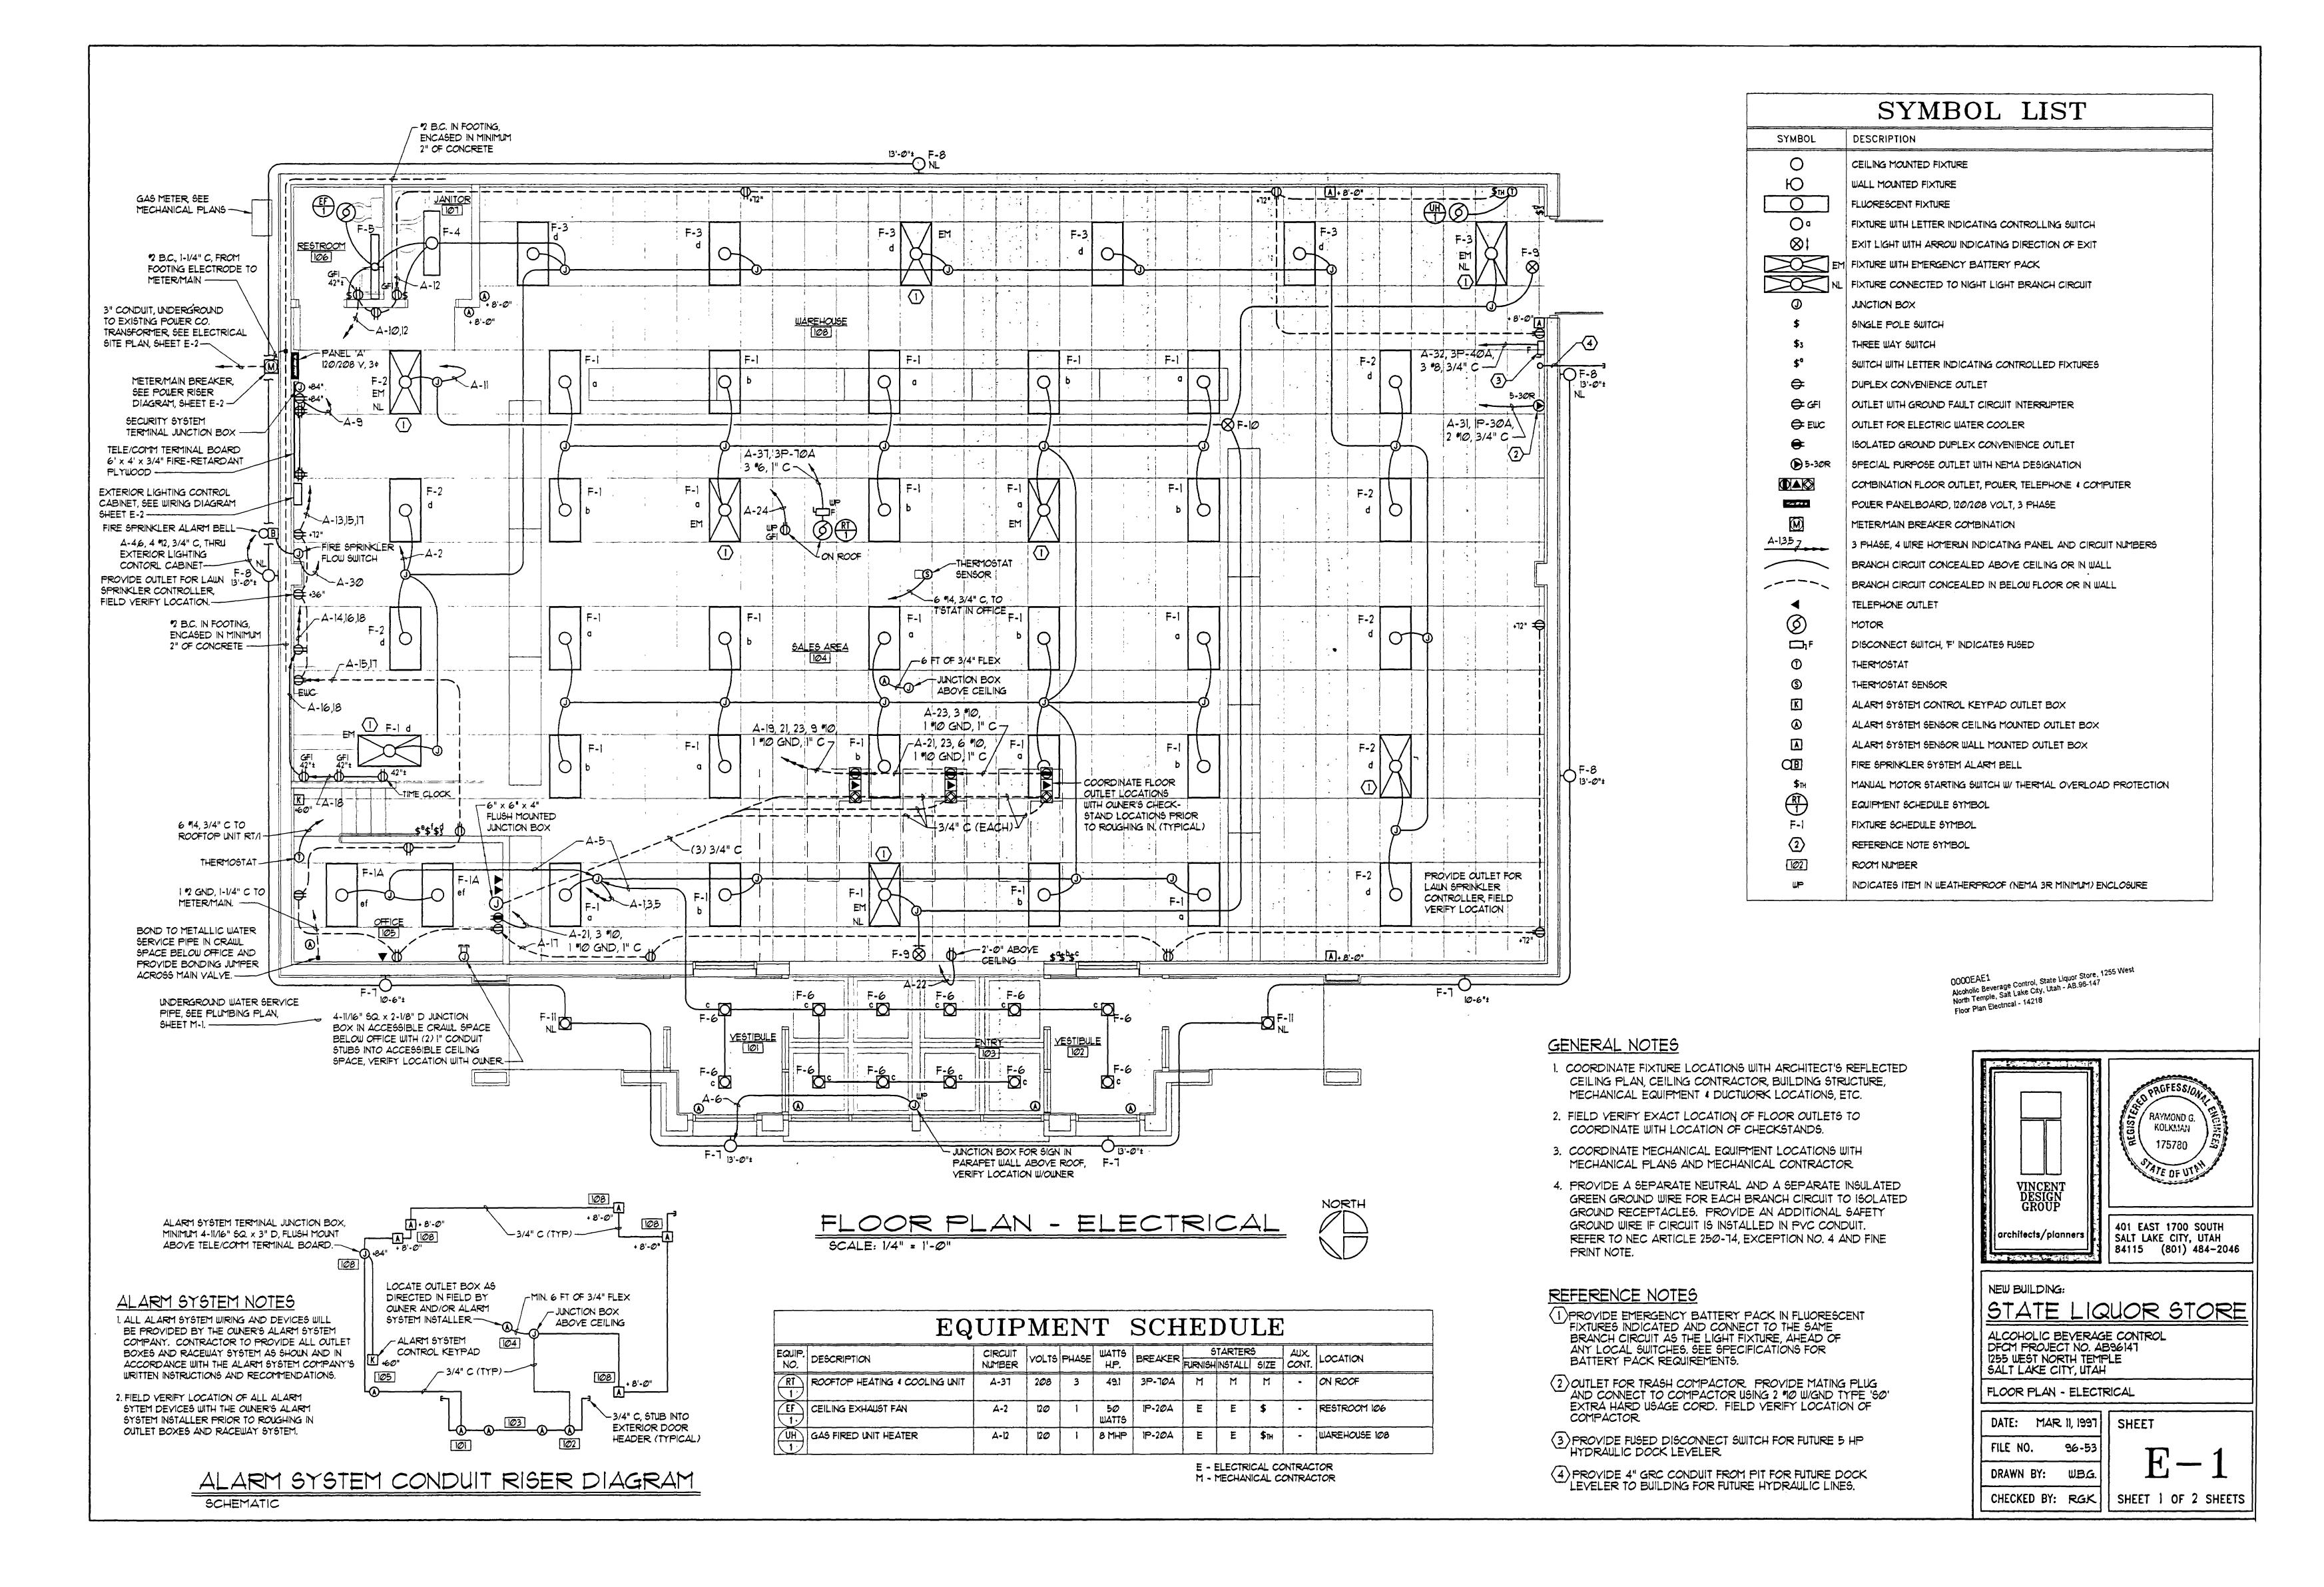

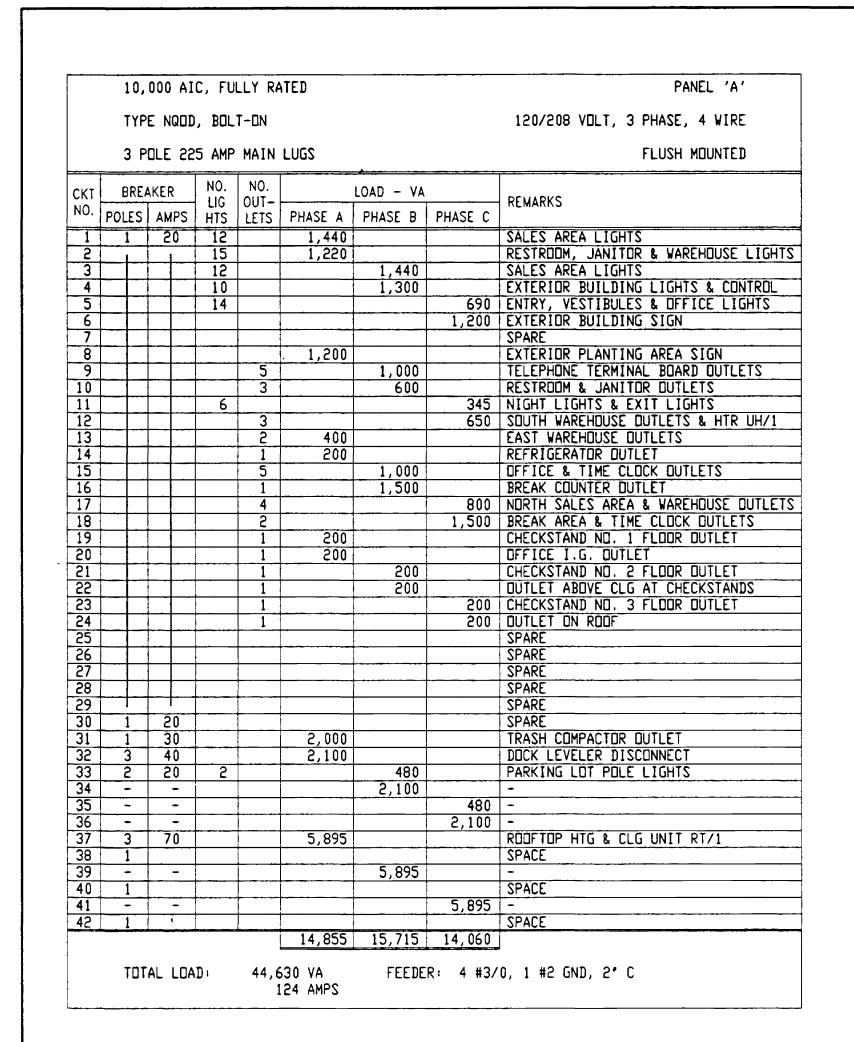TELEPHONE RISER DIAGRAM

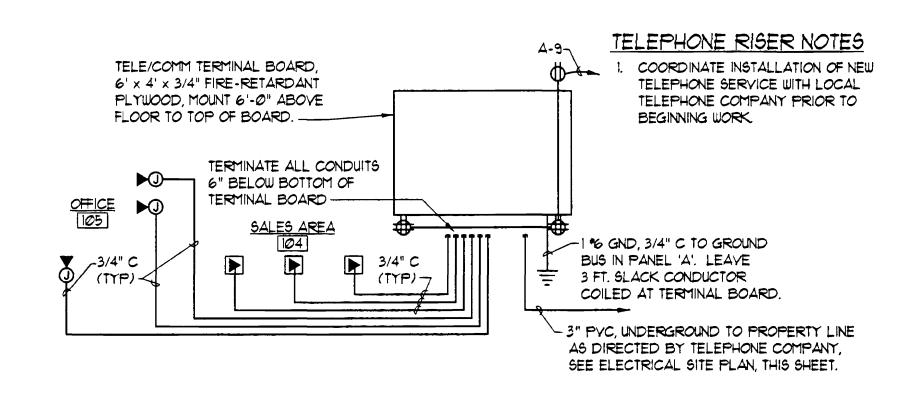

FIXTURE SCHEDULE SYMBOL MANUFACTURER CATALOG NUMBER DESCRIPTION LAMP LIGHTOLIER PRS2GRFVB432-120/04-10 2' X 4', 4 LAMP, STATIC LAY-IN FLUORESCENT FIXTURE 4F032T8/35K LITHONIA 2SPGB432-RW-A12.125-WITH FLOATING REGRESSED ALUMINUM DOOR, BLACK REVEAL 120GEB10-1/4-SLL 0.125' THICK ACRYLIC PRISMATIC LENS, SPRING LDADED 50G-D24-432-RWKA125-E/ DOOR LATCHES AND ONE (1) 4 LAMP, 120 VOLT ELECTRONIC WILLIAMS 120-10% LIGHTOLIER PRS2GRFVB432-120/SD-10 SAME AS F-1 EXCEPT WITH TWO (2) 2 LAMP 120 VOLT 4F032T8/35K ELECTRONIC BALLASTS WIRED FOR INBOARD/OUTBOARD LAMP AINOHTI 2SPGB432-RW-A12.125-120GEB10-SLL OPERATION. WILLIAMS 50G-D24-432-RVKA125-(2)E232/120-10% F-2 LIGHTOLIER PRS2GRFVB332-120/03-10 SAME AS F-1 EXCEPT 3 LAMP WITH DNE (1) 3 LAMP 120 VOLT | 3F032T8/35K ELECTRONIC BALLAST. LITHONIA 2SPGB332-RW-A12.125-120GEB10-1/3-SLL WILLIAMS 50G-D24-332-RVKA125-E/ 120-10% F-3 LIGHTOLIER PRS2GRFVB332-120/SD-10 SAME AS F-1 EXCEPT 2 LAMP WITH DNE (1) 2 LAMP 120 VOLT | 2F032T8/35K LITHONIA 2SPGB232-RW-A12.125-ELECTRONIC BALLAST. 120GEB10-SLL WILLIAMS 50G-D24-232-RWKA125-E/ 120-10% F-4 LIGHTDLIER KLT232-120/SD-10 SURFACE MOUNTED, 2 LAMP, FLUDRESCENT FIXTURE WITH 2F032T8/35K LITHONIA LB232A-120GEB10 ACRYLIC PRISMATIC LENS AND 120 VOLT ELECTRONIC WILLIAMS 17-4-232-A-E/120-10% F-5 DAY-BRIT CB232W-120-EB-10 WALL MOUNTED FLUORESCENT FIXTURE WITH INJECTION MOLDED | 2F032T8/35K ACRYLIC PRISMATIC LENS, WHITE FINISH, UP & DOWN LIGHT LIGHTOLIER CABX535DA-150\20-10 PRUDENTIAL P-1862-48CTE10-PRA-120 AND 120 VOLT ELECTRONIC BALLAST. RECESSED COMPACT FLUORESCENT DOWNLIGHT WITH SPECULAR F-6 INFINITY PH75-126Q-120V-CS 1F26DTT/35K LIGHTOLIER 8065-CL/7126-HM120 CLEAR ALZAK REFLECTOR, THERMAL PROTECTION AND 120 VOLT AF-1/26DTT-8AR-120V HIGH POWER FACTOR BALLAST. LITHONIA MCPHILBEN 102-FT-100HPS-120-BGP WALL MOUNTED HIGH PRESSURE SODIUM FIXTURE WITH CLEAR 100 W HPS, TEMPERED GLASS LENS, CAST ALUMINUM HOUSING, SPECULAR ED-17 ALZAK REFLECTOR, FORWARD THROW LIGHT DISTRIBUTION, BEIGE POLYESTER POWDER COAT FINISH MEDIUM BASE LAMP AND 120 VOLT HIGH POWER FACTOR BALLAST. MAXIMUM FIXTURE HEIGHT OF 11" DAY-BRITE | WLM100S-120 WALL MOUNTED HIGH PRESSURE SODIUM FIXTURE WITH 100 W HPS, F-8 PRISMATIC TEMPERED GLASS LENS, CAST ALUMINUM HOUSING, 313100HLXL-1 ED-17 EXCELINE WP2SH100-120 DARK BRONZE FINISH, MEDIUM BASE LAMP AND 120 VOLT HIGH POWER FACTOR BALLAST. WA-LEDP-XN-1-G FURNISHED EMERGI-LITE CEILING MOUNTED LIGHT EMITTING DIDDE (LED) EXIT LIGHT WITH GREEN LETTERS ON BRUSHED ALUMINUM STENCIL FACE, ZBP-CLED-2-G-WS-ZCBN HIGH-LITES W/FIXTURE PRISMATIC DIFFUSER, CAST ALUMINUM HOUSING WITH BLACK LITHONIA LE-S-1-G-120/277-ELN FINISH, SEALED MAINTENANCE FREE NICKEL CADMIUM BATTERY PACK WITH CHARGER, INDICATOR LIGHT AND TEST SWITCH. THREE (3) YEAR FULL WARRANTY WITH ADDITIONAL SEVEN (7) YEAR PRO-RATA BATTERY WARRANTY. SAME AS F-8 EXCEPT DOUBLE FACED. EMERGI-LITE WA-LEDP-XN-2-G FURNISHED ZBP-CLED-3-G-WS-ZCBN W/FIXTURE HIGH-LITES LITHONIA LE-S-2-G-120/277-ELN 100 W HPS, 8100S-BKB-120-FL RECESSED HIGH PRESSURE SODIUM DOWNLIGHT WITH TEMPERED F-11 GLASS FRESNEL LENS. BLACK: GROOVED BAFFLE, THERMAL INFINITY HPSHPSRL10-100-FF-MB-PROTECTION AND 120 VOLT HIGH POWER FACTOR BALLAST. AINDHTI LGH100S-9SB-FFL-120HPF GARDOD EH19-1-Q-400JPS-208-BRP/ F-12 HIGH PRESSURE SODIUM PARKING LOT FIXTURE WITH EXTRUDED | 400 W HPS SSS-35-5-7-D1-BRP ALUMINUM HOUSING, CLEAR TEMPERED GLASS LENS, TYPE V LIGHT DISTRIBUTION, DARK BRONZE FINISH AND 208 VOLT LITHONIA KSF2-400S-R5S-208-SP09/ SSS-35-5G-DM19-SBC5-DDB HIGH POWER FACTOR BALLAST MOUNTED ON 35 FT. 5' SQUARE WIDELITE STRAIGHT STEEL POLE WITH WEATHERPROOF HANDHOLE COVER. S10S400-5-208-S-DB/ GROUND LUG IN HANDHOLE, ALUMINUM ANCHOR BOLT COVER AND SSP35-5-7-BRZ-DM10-BC DARK BRONZE FINISH TO MATCH FIXTURE.

EXTERIOR LIGHTING CONTROL DEVICES

- CB1 CONTROL CIRCUIT BREAKER, 120 VOLT, 5 AMP THERMAL MAGNETIC TRIP SQUARE D CLASS 9080, TYPE GCB50 OR EQUAL. INSTALL ON TERMINAL BLOCK MOUNTING RAIL IN CONTROL CABINET.
- SS1 SELECTOR SWITCH, 3 POSITION, MAINTAINED CONTACT, WITH 2 N.O. & 2 N.C. CONTACTS RATED 10 AMPS, STANDARD BLACK KNOB AND LEGEND PLATE: SQUARE D CLASS 9001, TYPE KS43BH2/KN360 OR EQUAL. INSTALL IN FRONT COVER OF CONTROL CABINET.
- PC1 PHOTOCELL, 2000 WATT, 120 VOLT, WITH SPST CONTACTS: TORK #2101 DR EQUAL. MOUNT ON ROOF OR OUTSIDE WALL FACING NORTH AND AWAY FROM ANY DIRECT LIGHT SOURCES.
- TS1 TIME SWITCH, ELECTRONIC, 120 VAC WITH 5 AMP SPST CONTACT AND NICKEL CADMIUM BATTERY BACKUP: INTERMATIC MODEL ET715-C OR EQUAL. INSTALL ADJACENT TO CONTROL CABINET.
- LC1 LIGHTING CONTACTOR, ELECTRICALLY HELD, WITH 6 POLE 20 AMP, 600 VOLT CONTACTS AND 120 VAC COIL: SQUARE D CLASS 8903, TYPE L060-V02 OR EQUAL. INSTALL IN CONTROL CABINET.
- LC2 LIGHTING CONTACTOR, ELECTRICALLY HELD, WITH 4 POLE 20 AMP, 600 VOLT CONTACTS AND 120 VAC COIL: SQUARE D CLASS 8903, TYPE L040-V02 OR EQUAL. INSTALL IN CONTROL CABINET.

 LIGHTING CONTROL CABINET, 12' W x 16' H x 6' D, NEMA 1 ENCLOSURE

PANEL: WIEGMAN #NIC-12166 DR EQUAL.

TERMINAL BLOCKS: 600 VOLT, FOR #22-#8 CONDUCTORS, PROVIDE WITH MOUNTING RAIL' FND RAPRIERS FTC. AS REQUIRED: SOLVAPE D. CLASS


WITH HINGED FRONT COVER, FLUSH LATCH AND EQUIPMENT MOUNTING

MOUNTING RAIL, END BARRIERS, ETC., AS REQUIRED: SQUARE D CLASS 9080, TYPE GR6 DR EQUAL. INSTALL IN CONTROL CABINET.

NOTESI

- USE MINIMUM #14 STRANDED WIRE FOR ALL CONTROL CONDUCTORS. LABEL WIRE ACCORDING TO NUMBER ON CONTROL DIAGRAM. SEE SPECIFICATION SECTION 16195.
- 2. REFER TO ELECTRICAL PLANS FOR POWER WIRE SIZES.
- 3. PROVIDE ENGRAVED NAMEPLATE FOR 'EXTERIOR LIGHTING CONTROL CABINET' IN ACCORDANCE WITH SPECIFICATION SECTION 16195. PROVIDE SELF-ADHESIVE LABEL TO INCLUDE CIRCUIT NUMBERS OF ALL CONTROL AND POWER CIRCUITS.
- PROVIDE SELF-ADHESIVE LABELS TO IDENTIFY ALL CONTROL DEVICES ACCORDING TO WIRING DIAGRAM.
- 5. PROVIDE DEVICES AS SPECIFIED OR EQUAL OF ACCEPTABLE MANUFACTURERS LISTED IN SPECIFICATION SECTION 16480.

) IP-20A TIME SWITCH POWER CONTROL POWER FUSE PHOTOCELL CONTROL 5 LCI 2 PHOTOCELL ON, TIME SWITCH PHOTOCELL ON, TIME SWITCH TS1-1 PHOTOCELL ON, PHOTOCELL OFF LIGHTING CONTACTOR EXTERIOR BUILDING LIGHTS BUILDING SIGN JUNCTION BOX PARKING LOT PLANTING AREA SIGN. ı ıLCI-4 SPARE PARKING LOT 2P-20A POLE LIGHTS EXTERIOR BUILDING NIGHT LIGHTS | |LC2-2 SPARE PARKING LOT POLE NIGHT LIGHTS

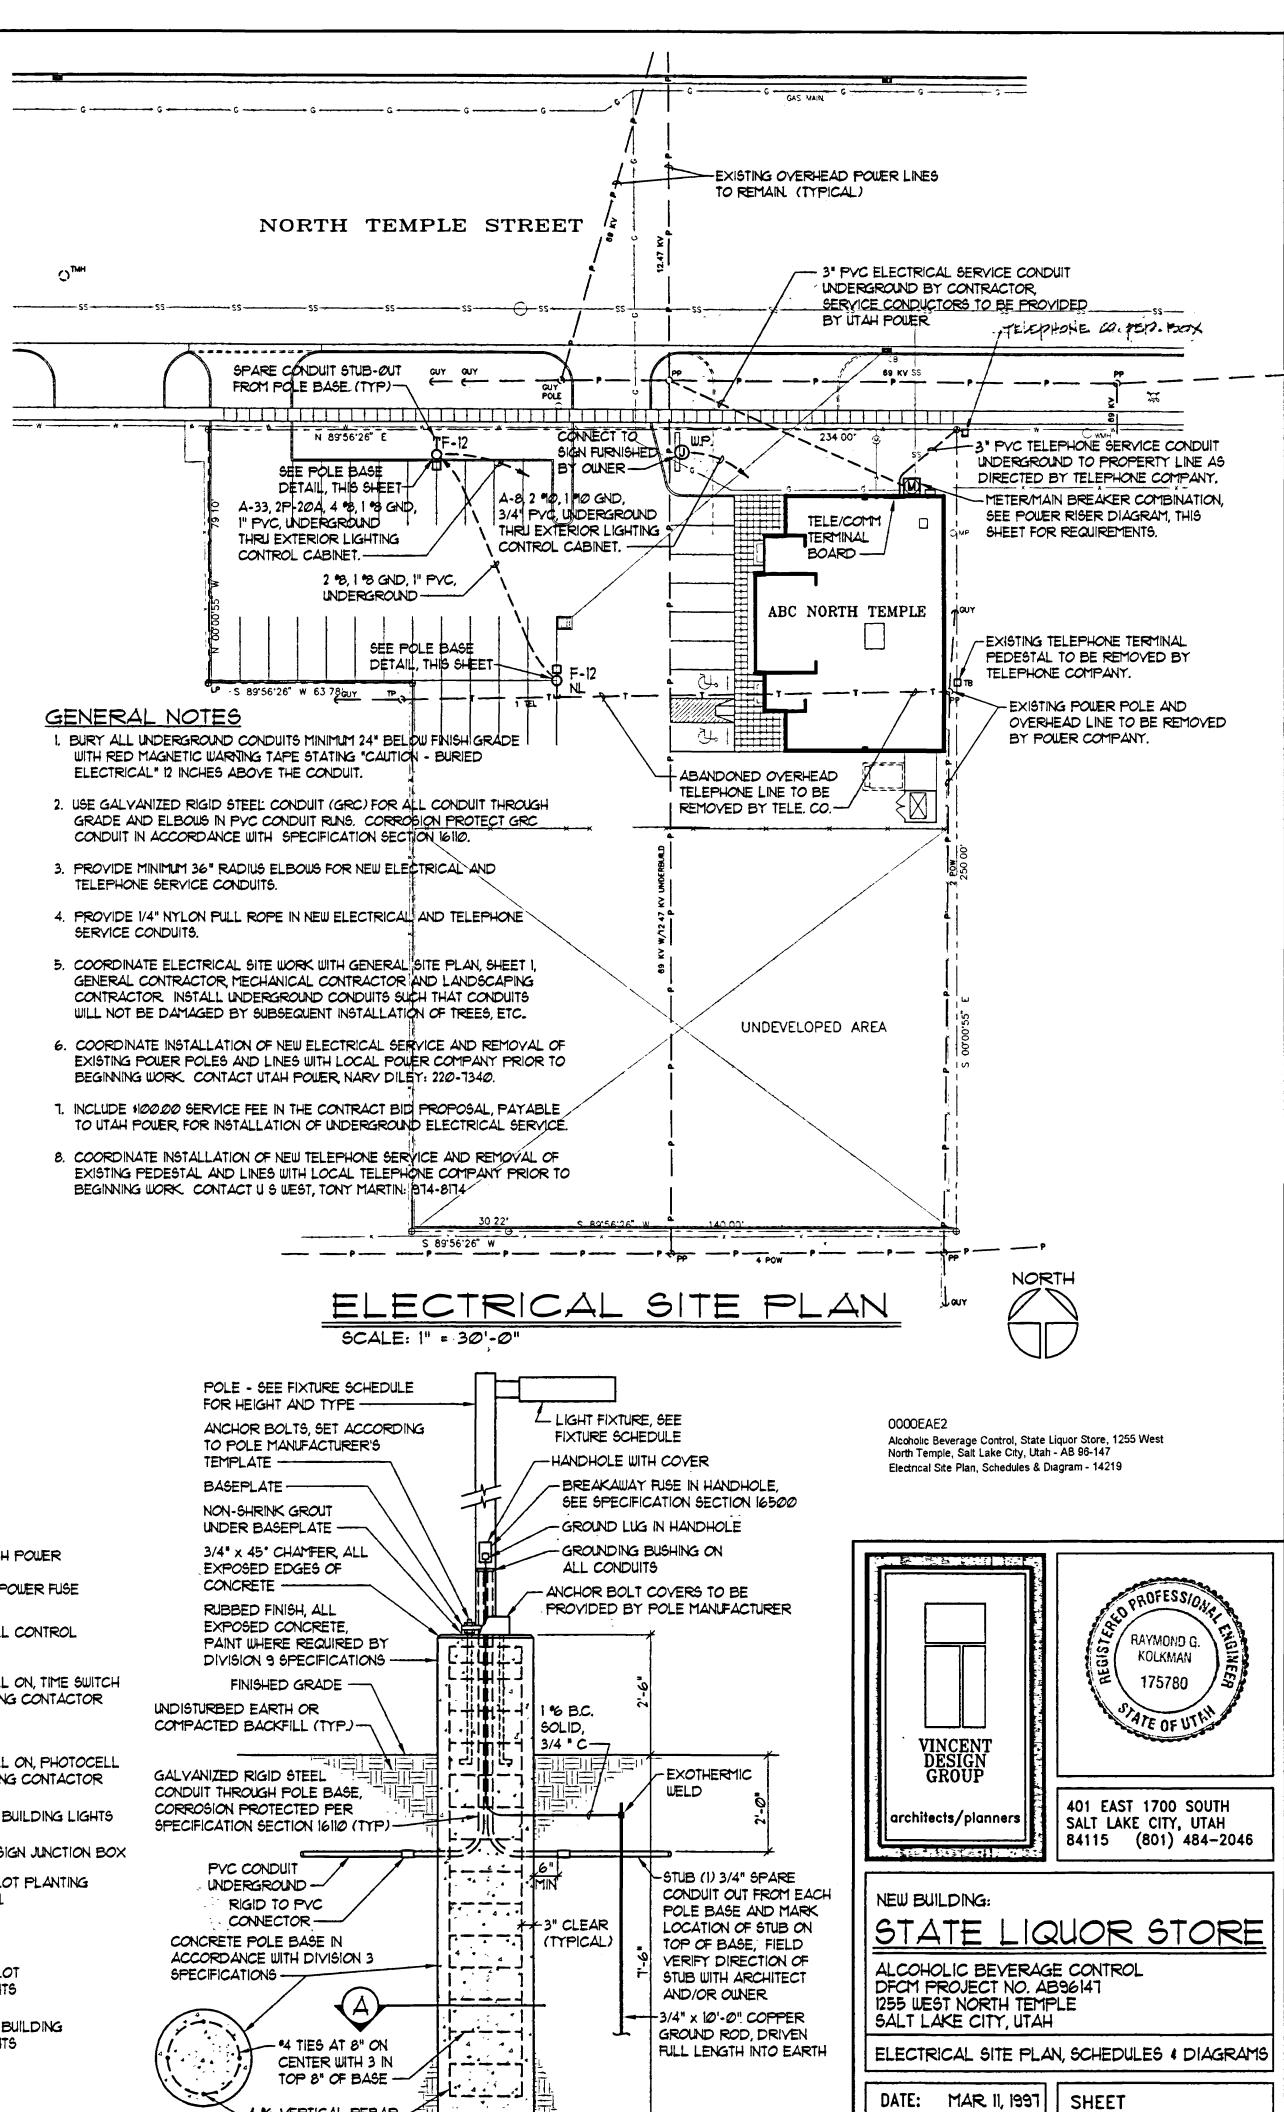

2'-0" DIA

SCALE: 1/2" = 1'-0"

POLE BASE DETAIL

FILE NO.

DRAWN BY:

CHECKED BY: RGK

96-53

SHEET 2 OF 2 SHEETS

EXTERIOR LIGHTING CONTROL WIRING DIAGRAM

SCHEMATIC

NEW BUILDING FOR:

STATE LIQUOR STORE

ALCOHOLIC BEVERAGE CONTROL DFCM PROJECT NO. AB97047

LIQUOR STORE #26 3905 WEST 5400 SOUTH TAYLORSVILLE, UTAH

ARCHITECTS: VINCENT DESIGN GROUP INC.

401 EAST 1700 SOUTH SALT LAKE CITY, UTAH (801) 484-2046

CONSULTANTS:

MECHANICAL:

GERALD D. SMITH & ASSOCIATES

(801) 262-6295

ELECTRICAL:

THOMAS & KOLKMAN ENGINEERING CO. INC.

(801) 484-8161

STRUCTURAL:


LARSEN & MALMQUIST CONSULTING ENGINEERS

(801) 972-2634

LANDSCAPE:

TIMPANOGOS LAND DESIGN

(801) 485-1217

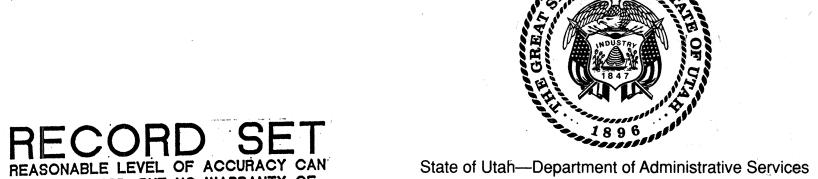


BE EXPECTED, BUT NO WARRANTY OF 100% ACCURACY IS MADE OR IMPLIED


CONTRACTOR YERIFIED AS-BUILTS - AUG. 25, 1998

SEPT. 10, 1998


DIVISION OF FACILITIES CONSTRUCTION AND MANAGEMENT
4110 State Office Building / Salt Lake City, Utah 84114 / 538-3018

The second secon			
·	LEGEND	&	SYMBOLS
ACOUST.	ACOUSTIC	SPEC.	SPECIFICATION
ADJ.	ADJUSTABLE	STL.	STEEL
ALUM.	ALUMINUM	TJI.	TRUSS JOIST
CER.TILE	CERAMIC TILE	REQ.	REQUIRED
CONC.	CONCRETE	W.C.	WATER CLOSET
CONT.	CONTINUOUS		
DET.	DETAIL		
ELEV.	ELEVATION		
EXIST/EX.	EXISTING		
EXP.	EXPANSION		
FLR.	FLOOR	P/L	PROPERTY LINE
F.D.	FLOOR DRAIN	FGE.	FINISH GRADE ELEVATION
GALV.	GALVANIZED	TBC.	TOP OF CURB ELEVATION
GA.	GUAGE	TCE.	TOP OF CONCRETE ELELVATION
GYP. BD.	GYPSUM BOARD	FFE.	FINISH FLOOR ELEVATION
INSUL.	INSULATION	— G —	GAS LINE
MAX.	MAXIMUM	——SS—	- SANITARY SEWER LINE
MM	MINIMUM	w	WATER LINE
MTL.	METAL	,	
N. I. C.	NOT IN CONTRACT		
OPN'G	OPENING	Þ	
REINF.	REINFORCED		
SHT.	SHEET		
* 0.Ç.	ON CENTER		

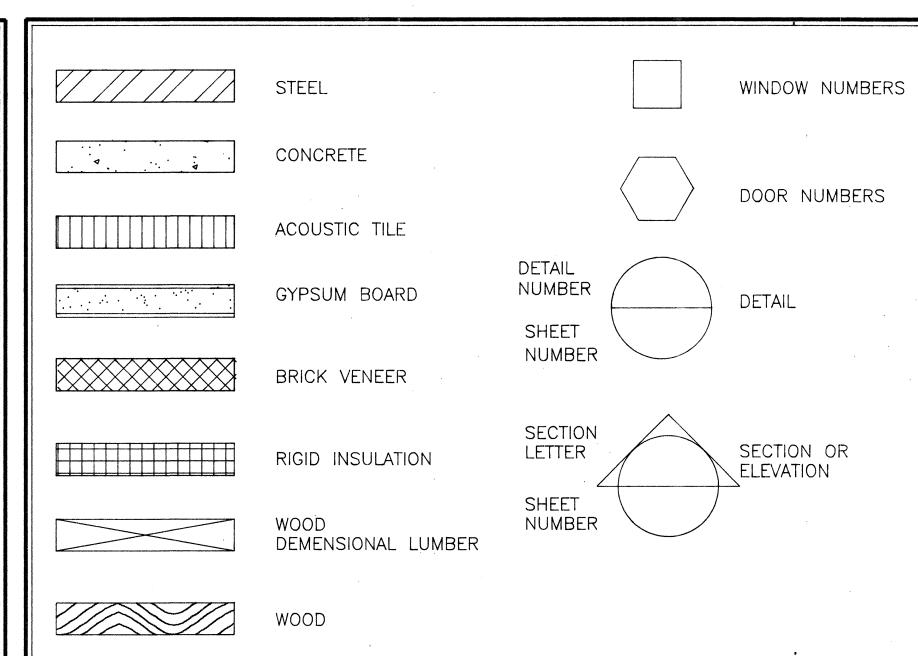

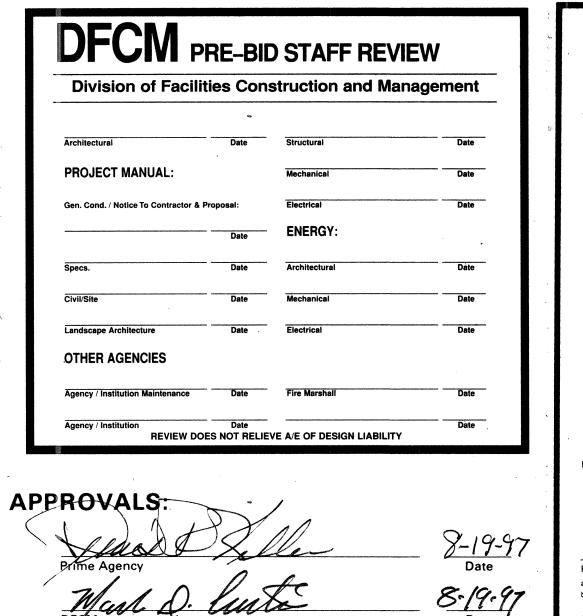


APPROVAL DOES NOT RELIEVE A/E OF DESIGN LIABILITY

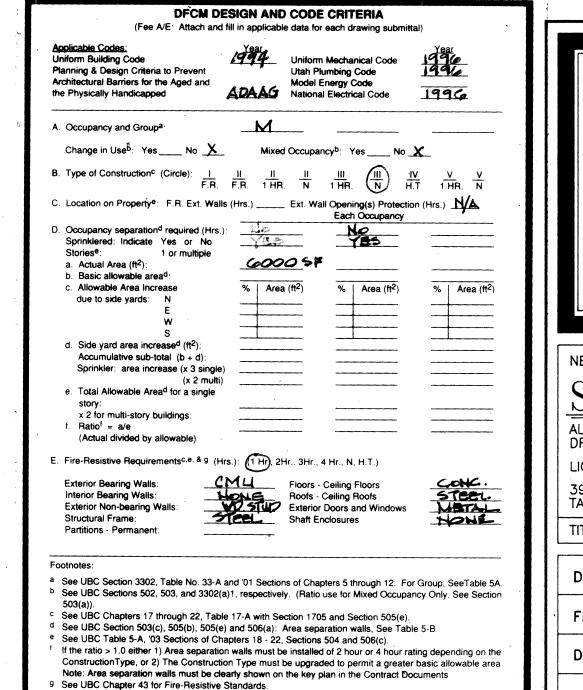




3905 WEST 5400 SOUTH TAYLORSVILLE, UTAH TITLE SHEET, INDEX, LEGEND & SYMBOLS SHEET **DATE** JULY 31, 1997 FILE NO. 97-30

____ DRAWN BY TJP CHECKED BY SHEET OF SHEETS

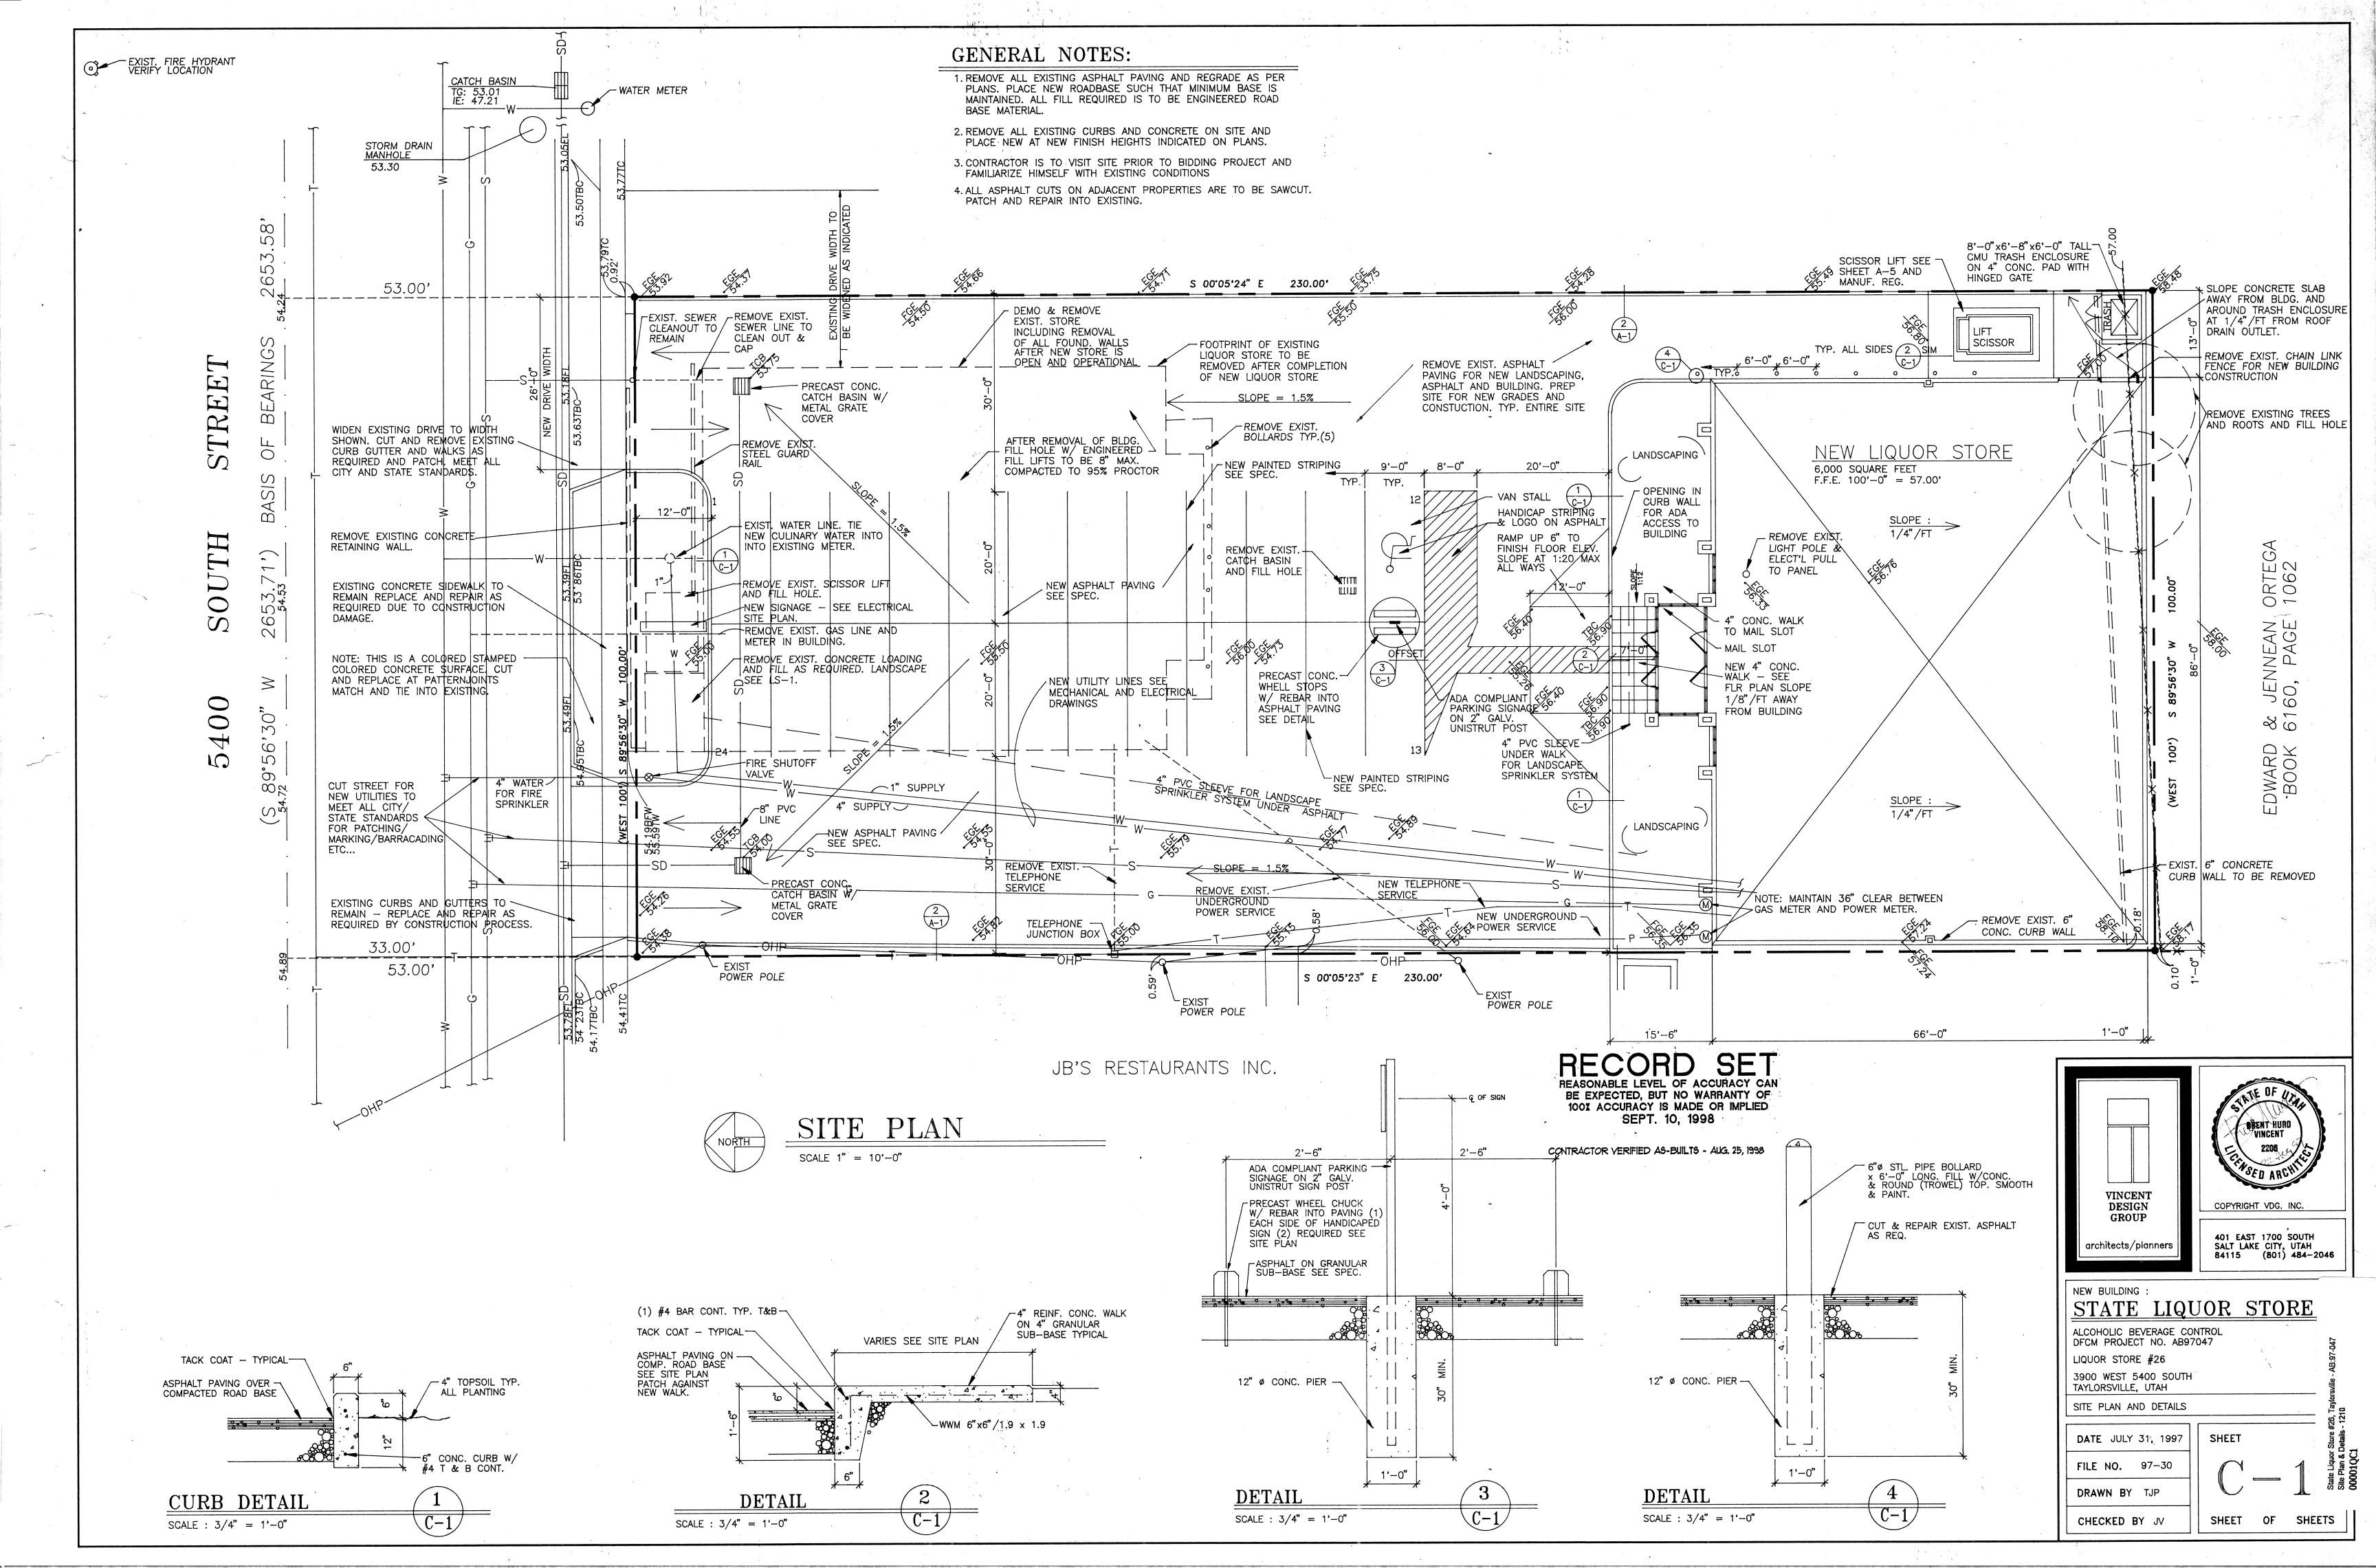

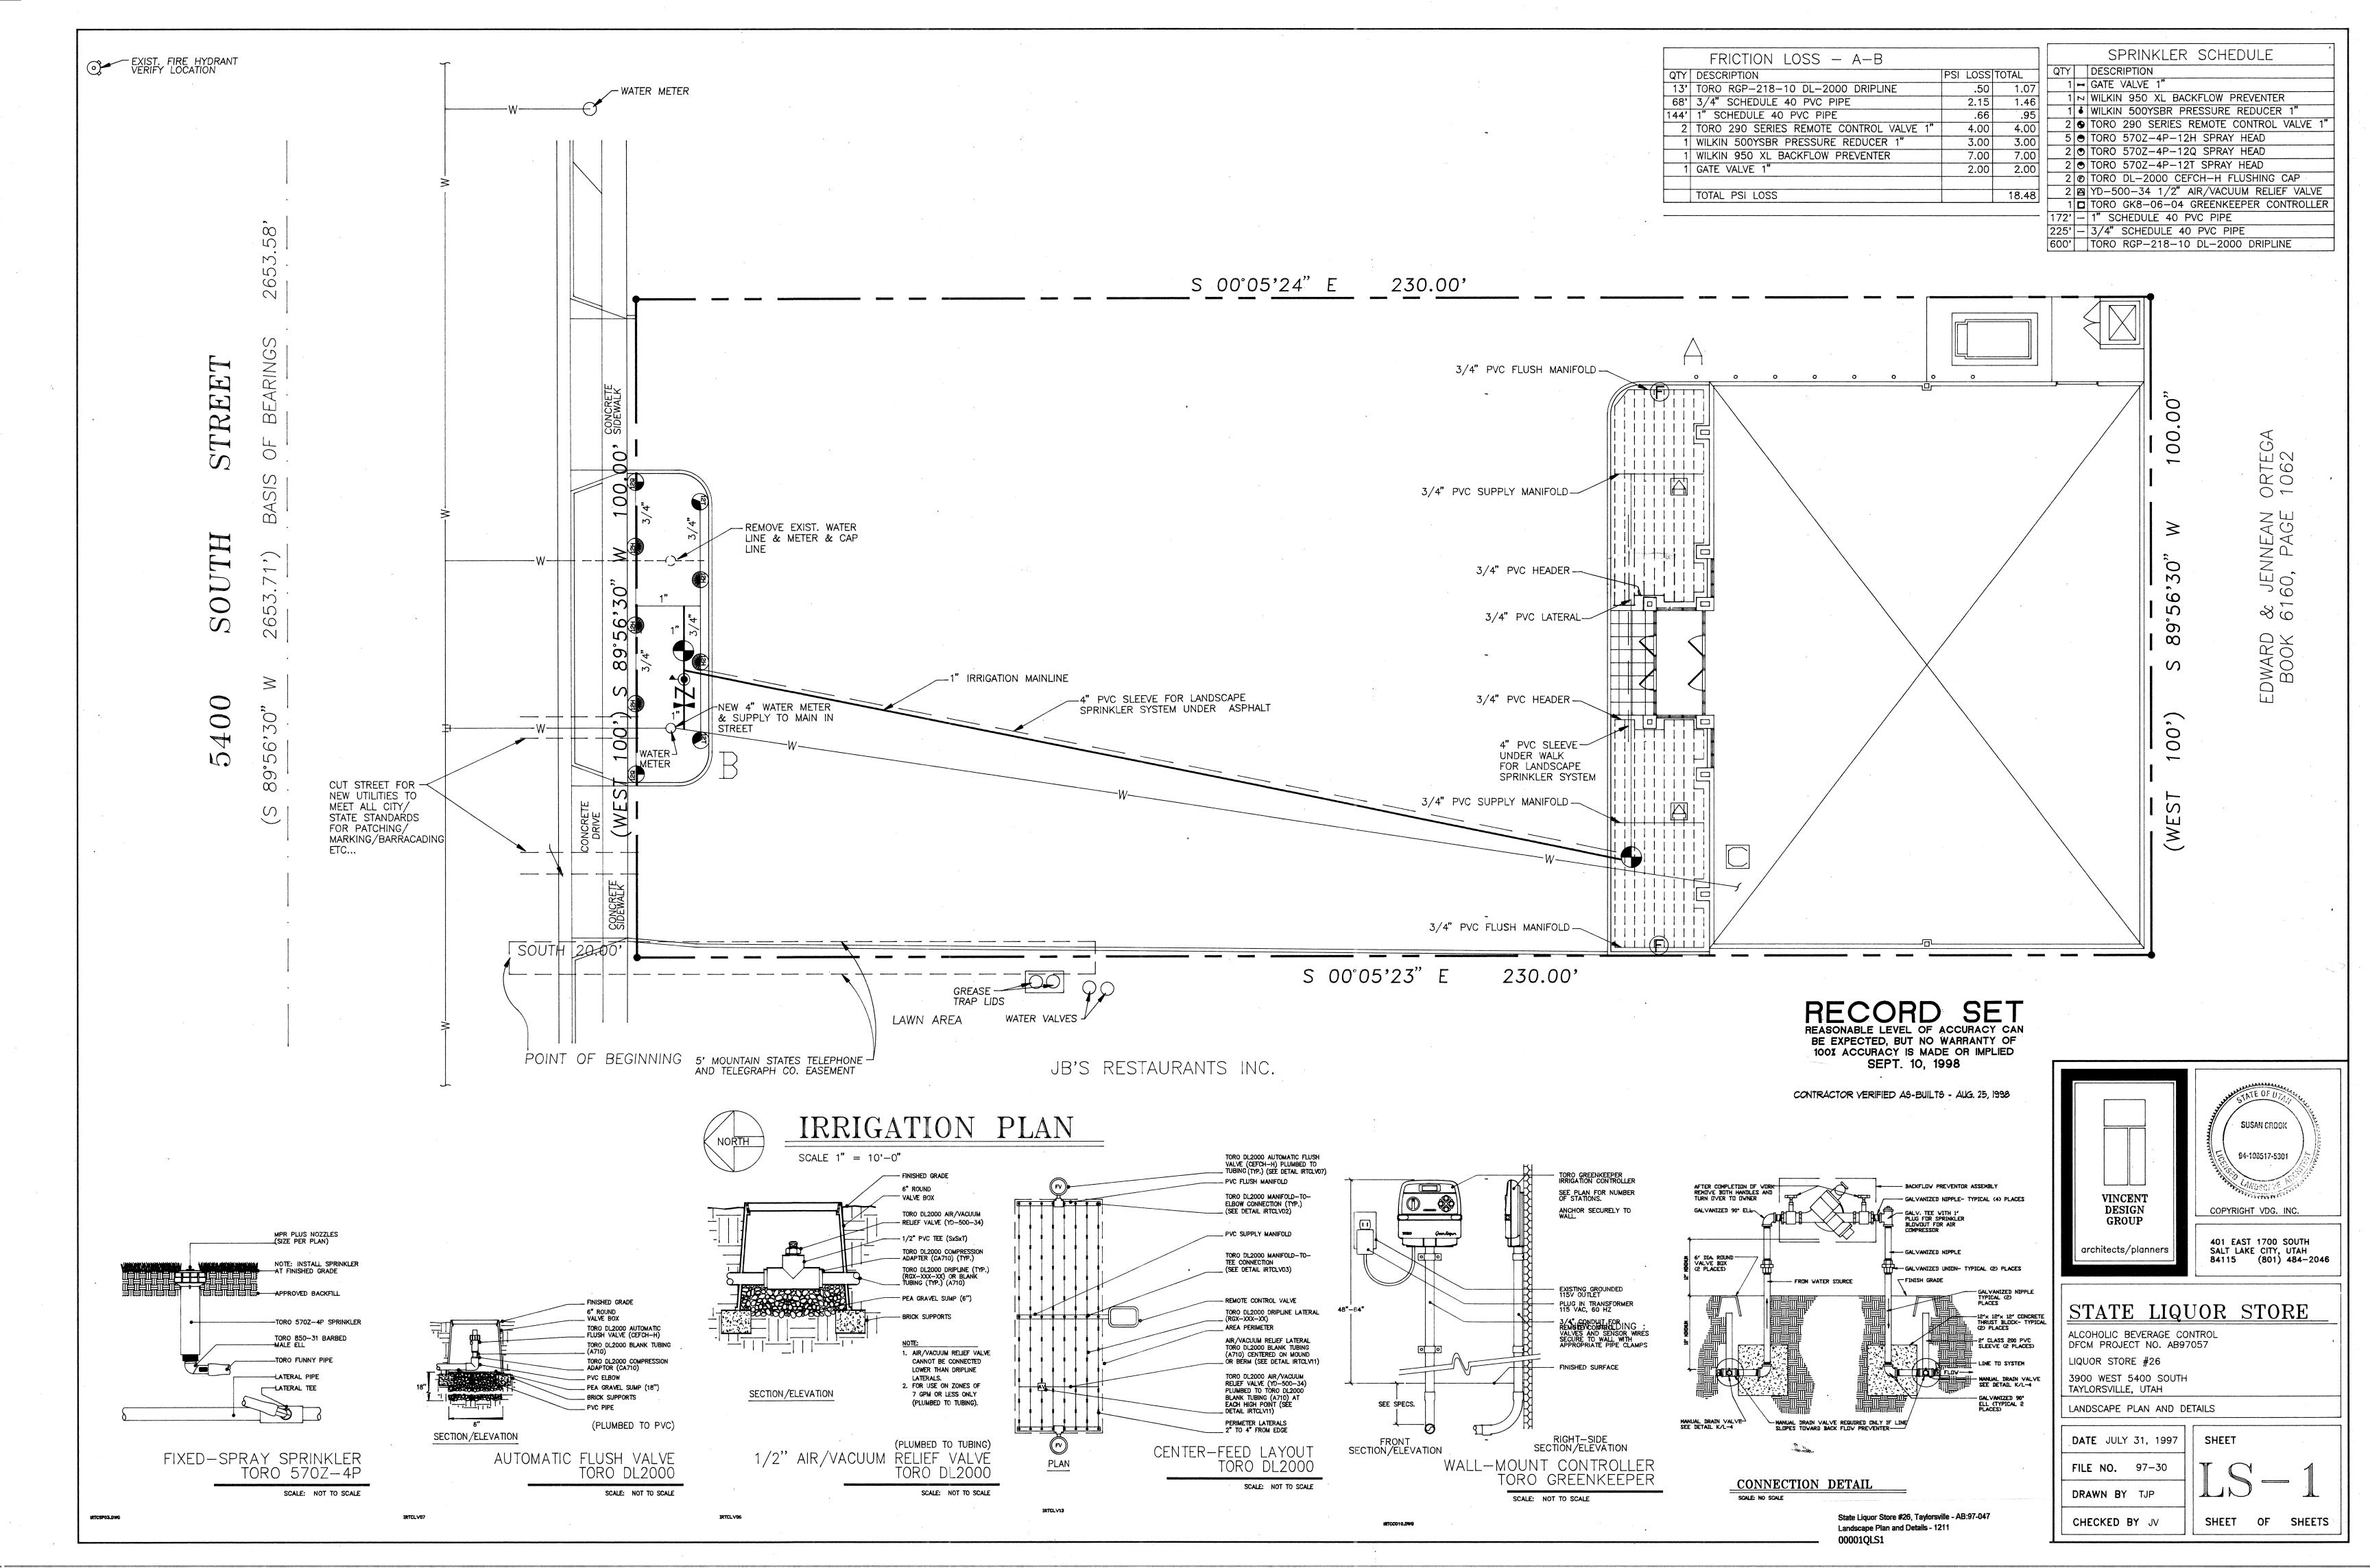

BEARINGS

VINCA MINOR (APP. 420 SQ. FT.) ORTEGA 1062 & JENNEAN 6160, PAGE 89.56,30" EDWARD BOOK

S 00°05'23" E 230.00' RECORD SET
REASONABLE LEVEL OF ACCURACY CAN
BE EXPECTED, BUT NO WARRANTY OF
100% ACCURACY IS MADE OR IMPLIED
SEPT. 10, 1998

CONTRACTOR VERIFIED AS-BUILTS - AUG. 25, 1998

POINT OF BEGINNING 5' MOUNTAIN STATES TELEPHONE -

100')

PLANTING PLAN

LAWN AREA

JB'S RESTAURANTS INC.

S 00°05'24" E

230.00'

SCALE 1" = 10'-0"

-BONSAI FESCUE LAWN (APP. 572 SQ. FT.)

GENERAL LANDSCAPING NOTES:

DL2000: FIRST ROW FROM HARDSCAPE IS NOT TO EXCEED 4". SPACE BETWEEN ROWS IS NOT TO EXCEED 18" AND IS TO BEEQUALLY SPACED.

LOCATE AIR VALVE AT HIGH POINT AS NEEDED. MINIMUM ONE PER PLANTER AREA.

INSTALL ONE MANUAL DRAIN PER VALVE BOX.


SLOPE ALL MAIN LINES AND LATERAL LINES TO MANUAL DRAINS. TYPICAL.

	PLANT SCHEDULE										
Symbol	Quantity	Scientific Name	Common Name	Size	Spacing	Comments					
0	2	Cercis canadensis	Eastern redbud	10-Gal	As shown	Clump					
	26	Vinca minor	Dwarf periwinkle	Flats (36 ea)	12" O.C.						
	572 sq. ft.		Bonsai fescue	Sod		Available from:					
						1. Lake Mtn. Farms, SLC, UT, 562-909					
						2. Turfco, Boise, ID, 808-888-3760					

(1)Cercis canadensis

VINCA MINOR (APP. 516 SQ. FT.) -

State Liquor Store #26, Taylorsville - AB:97-047 Landscape Planing Plan - 1212 00001QLS2

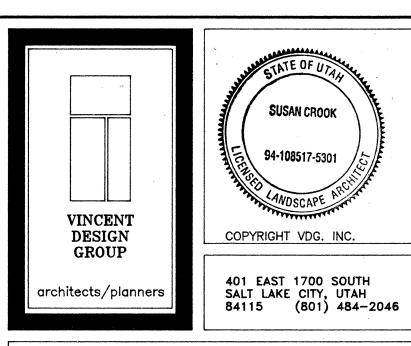

100')

(WE

NEW BUILDING : STATE LIQUOR STORE

ALCOHOLIC BEVERAGE CONTROL DFCM PROJECT NO. AB97057 LIQUOR STORE #26


3905 WEST 5400 SOUTH TAYLORSVILLE, UTAH LANDSCAPE PLANTING PLAN


DATE JULY 31, 1997


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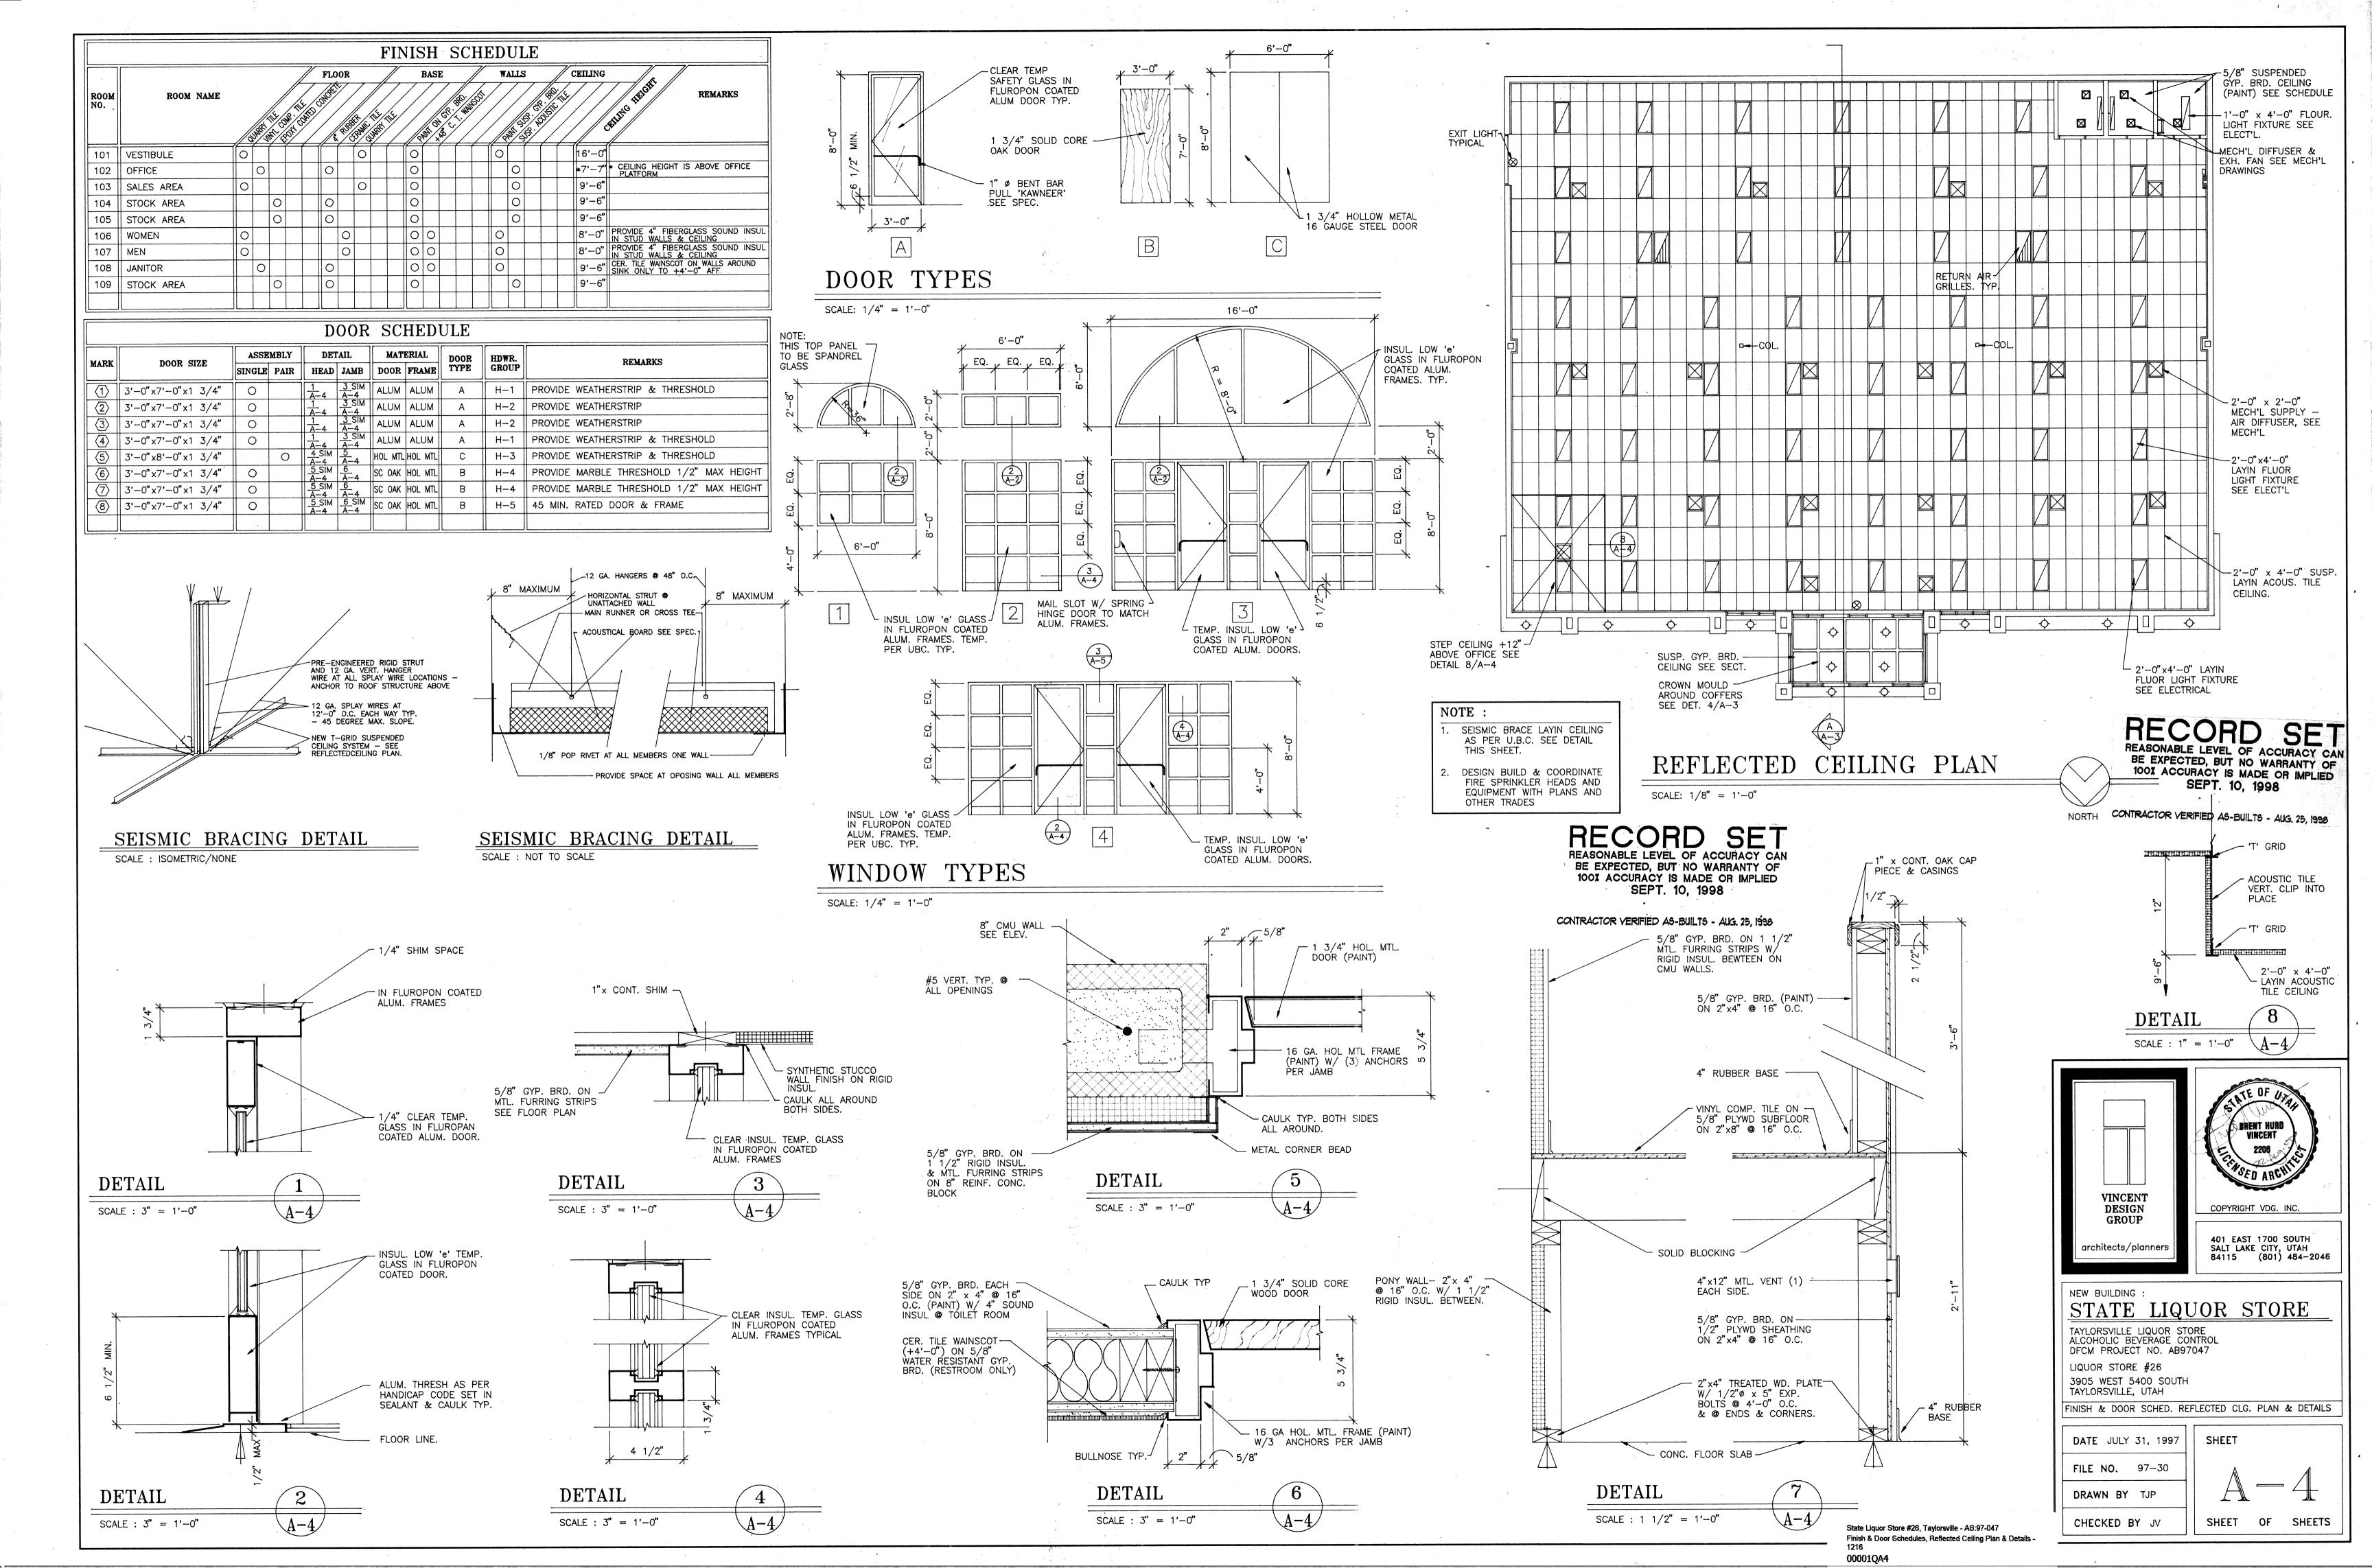
SHEET FILE NO. 97-30 DRAWN BY TJP


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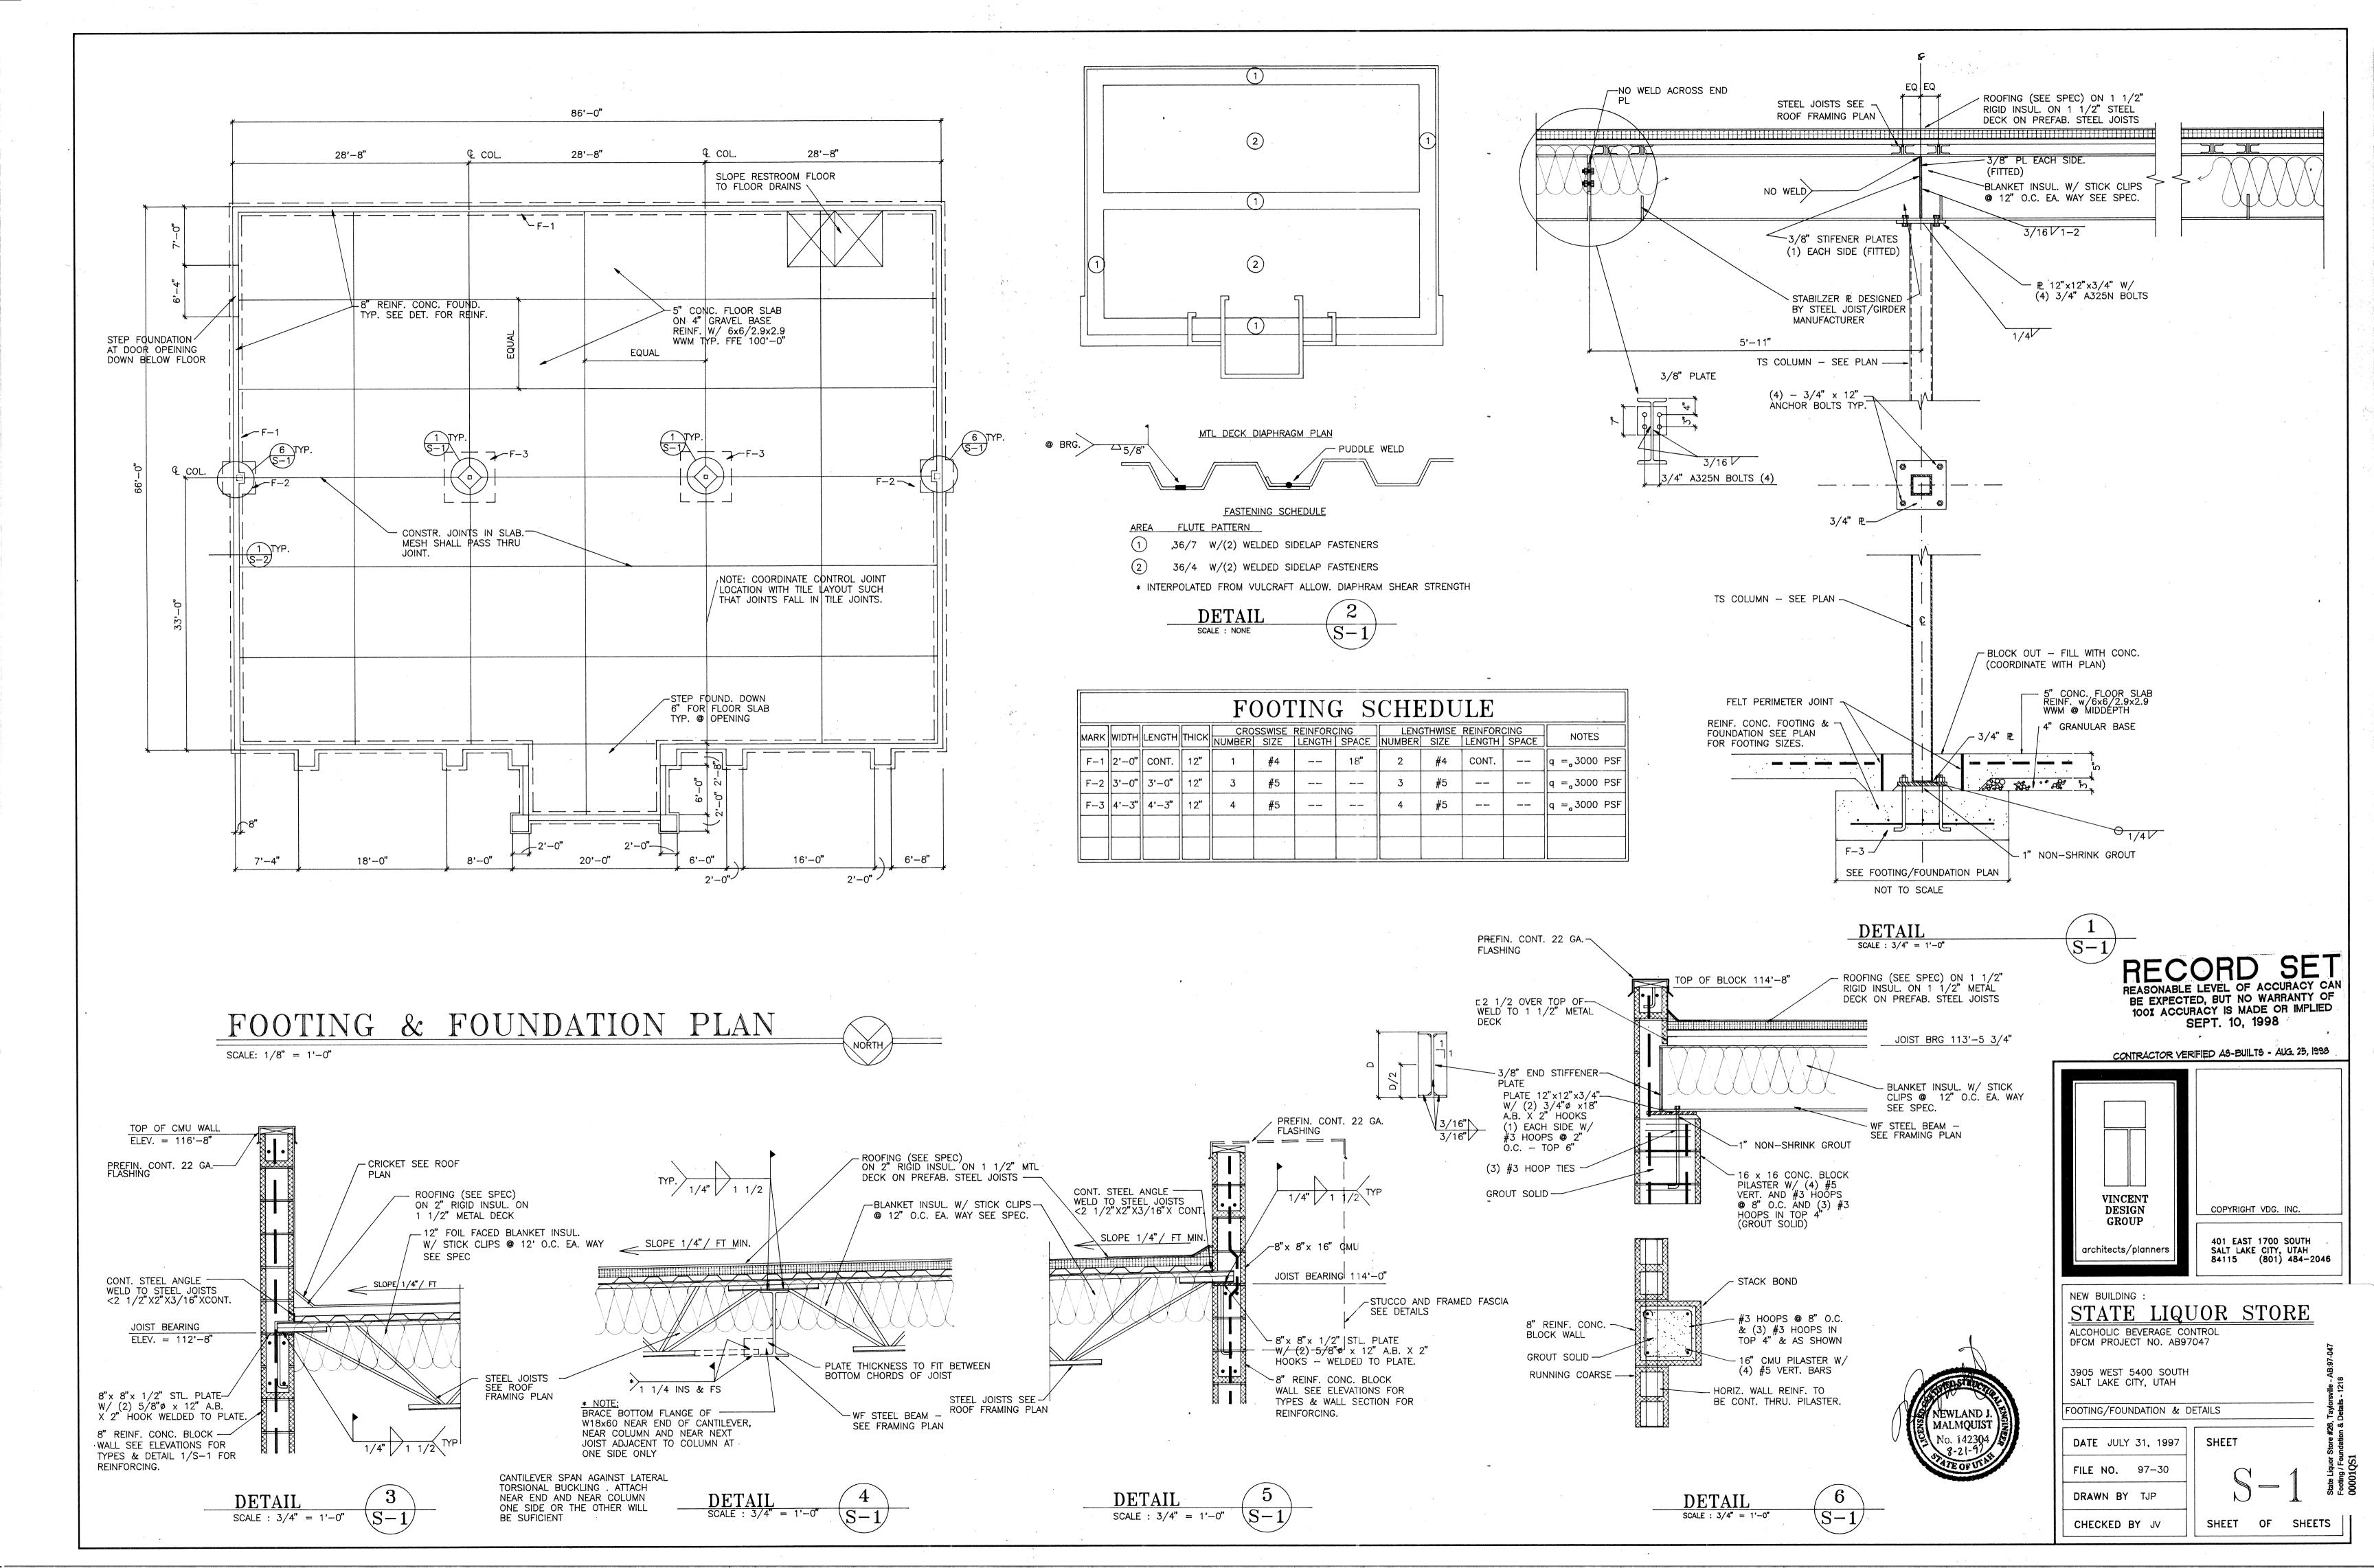





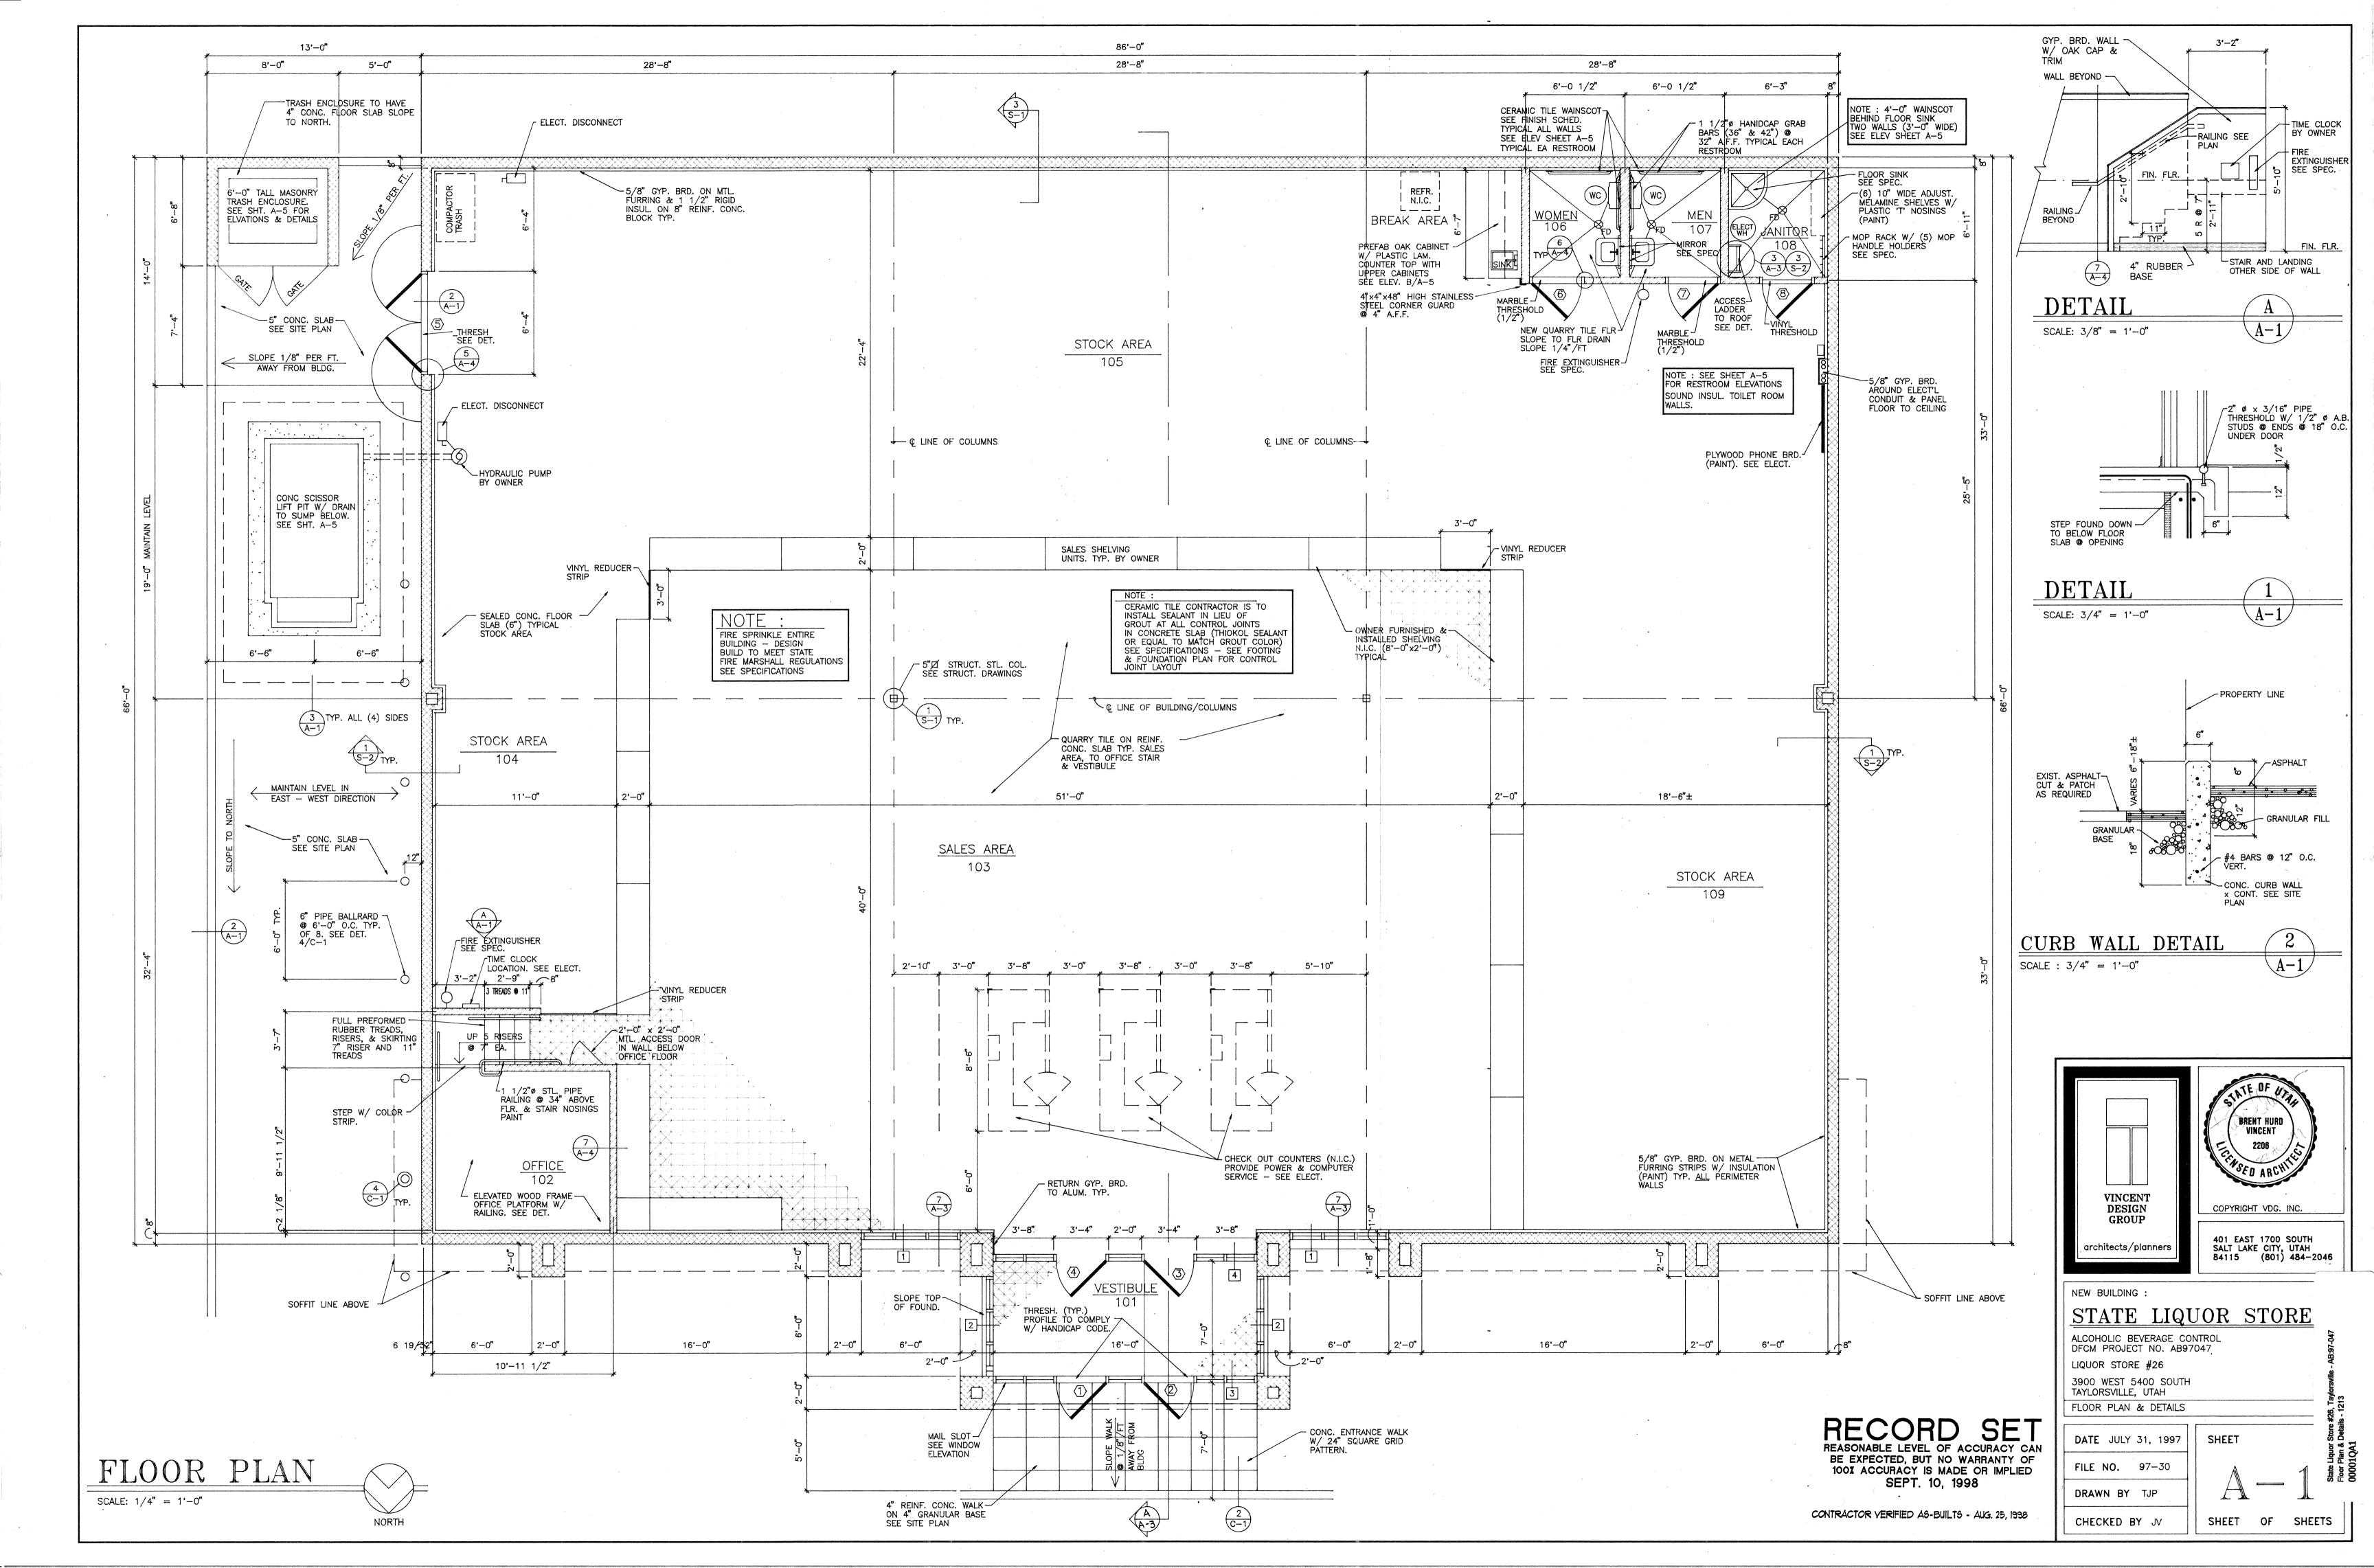


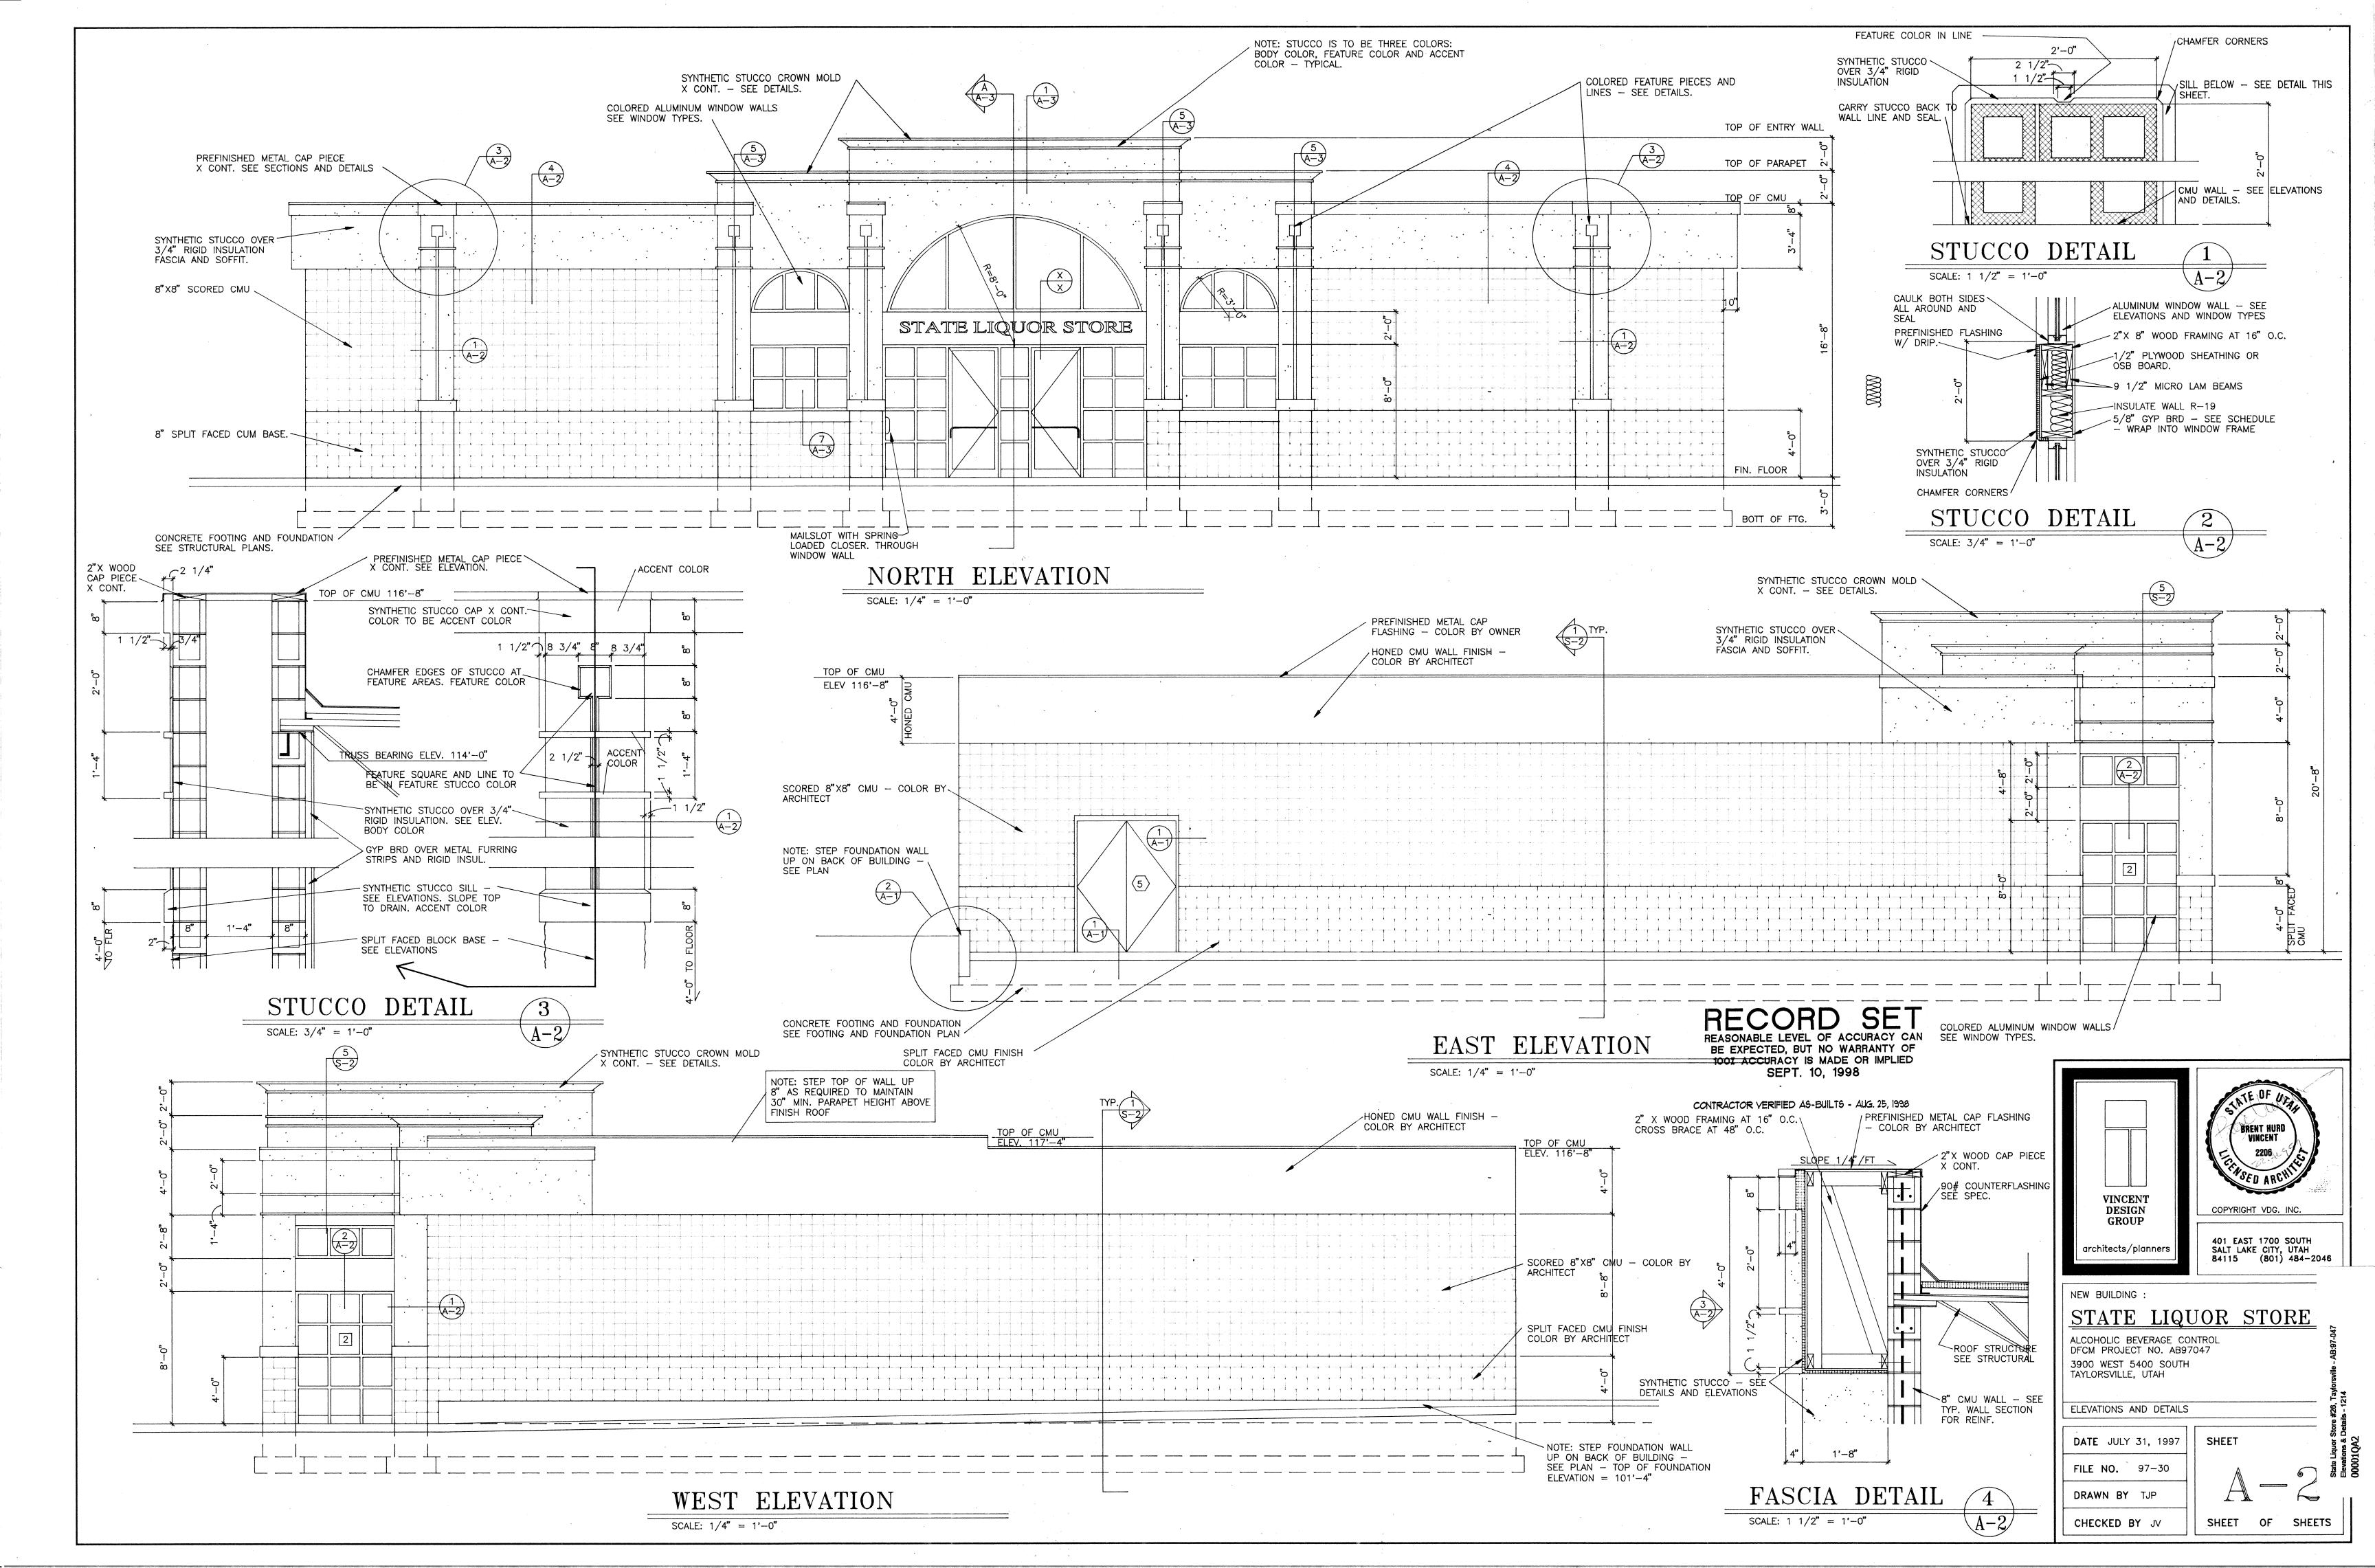


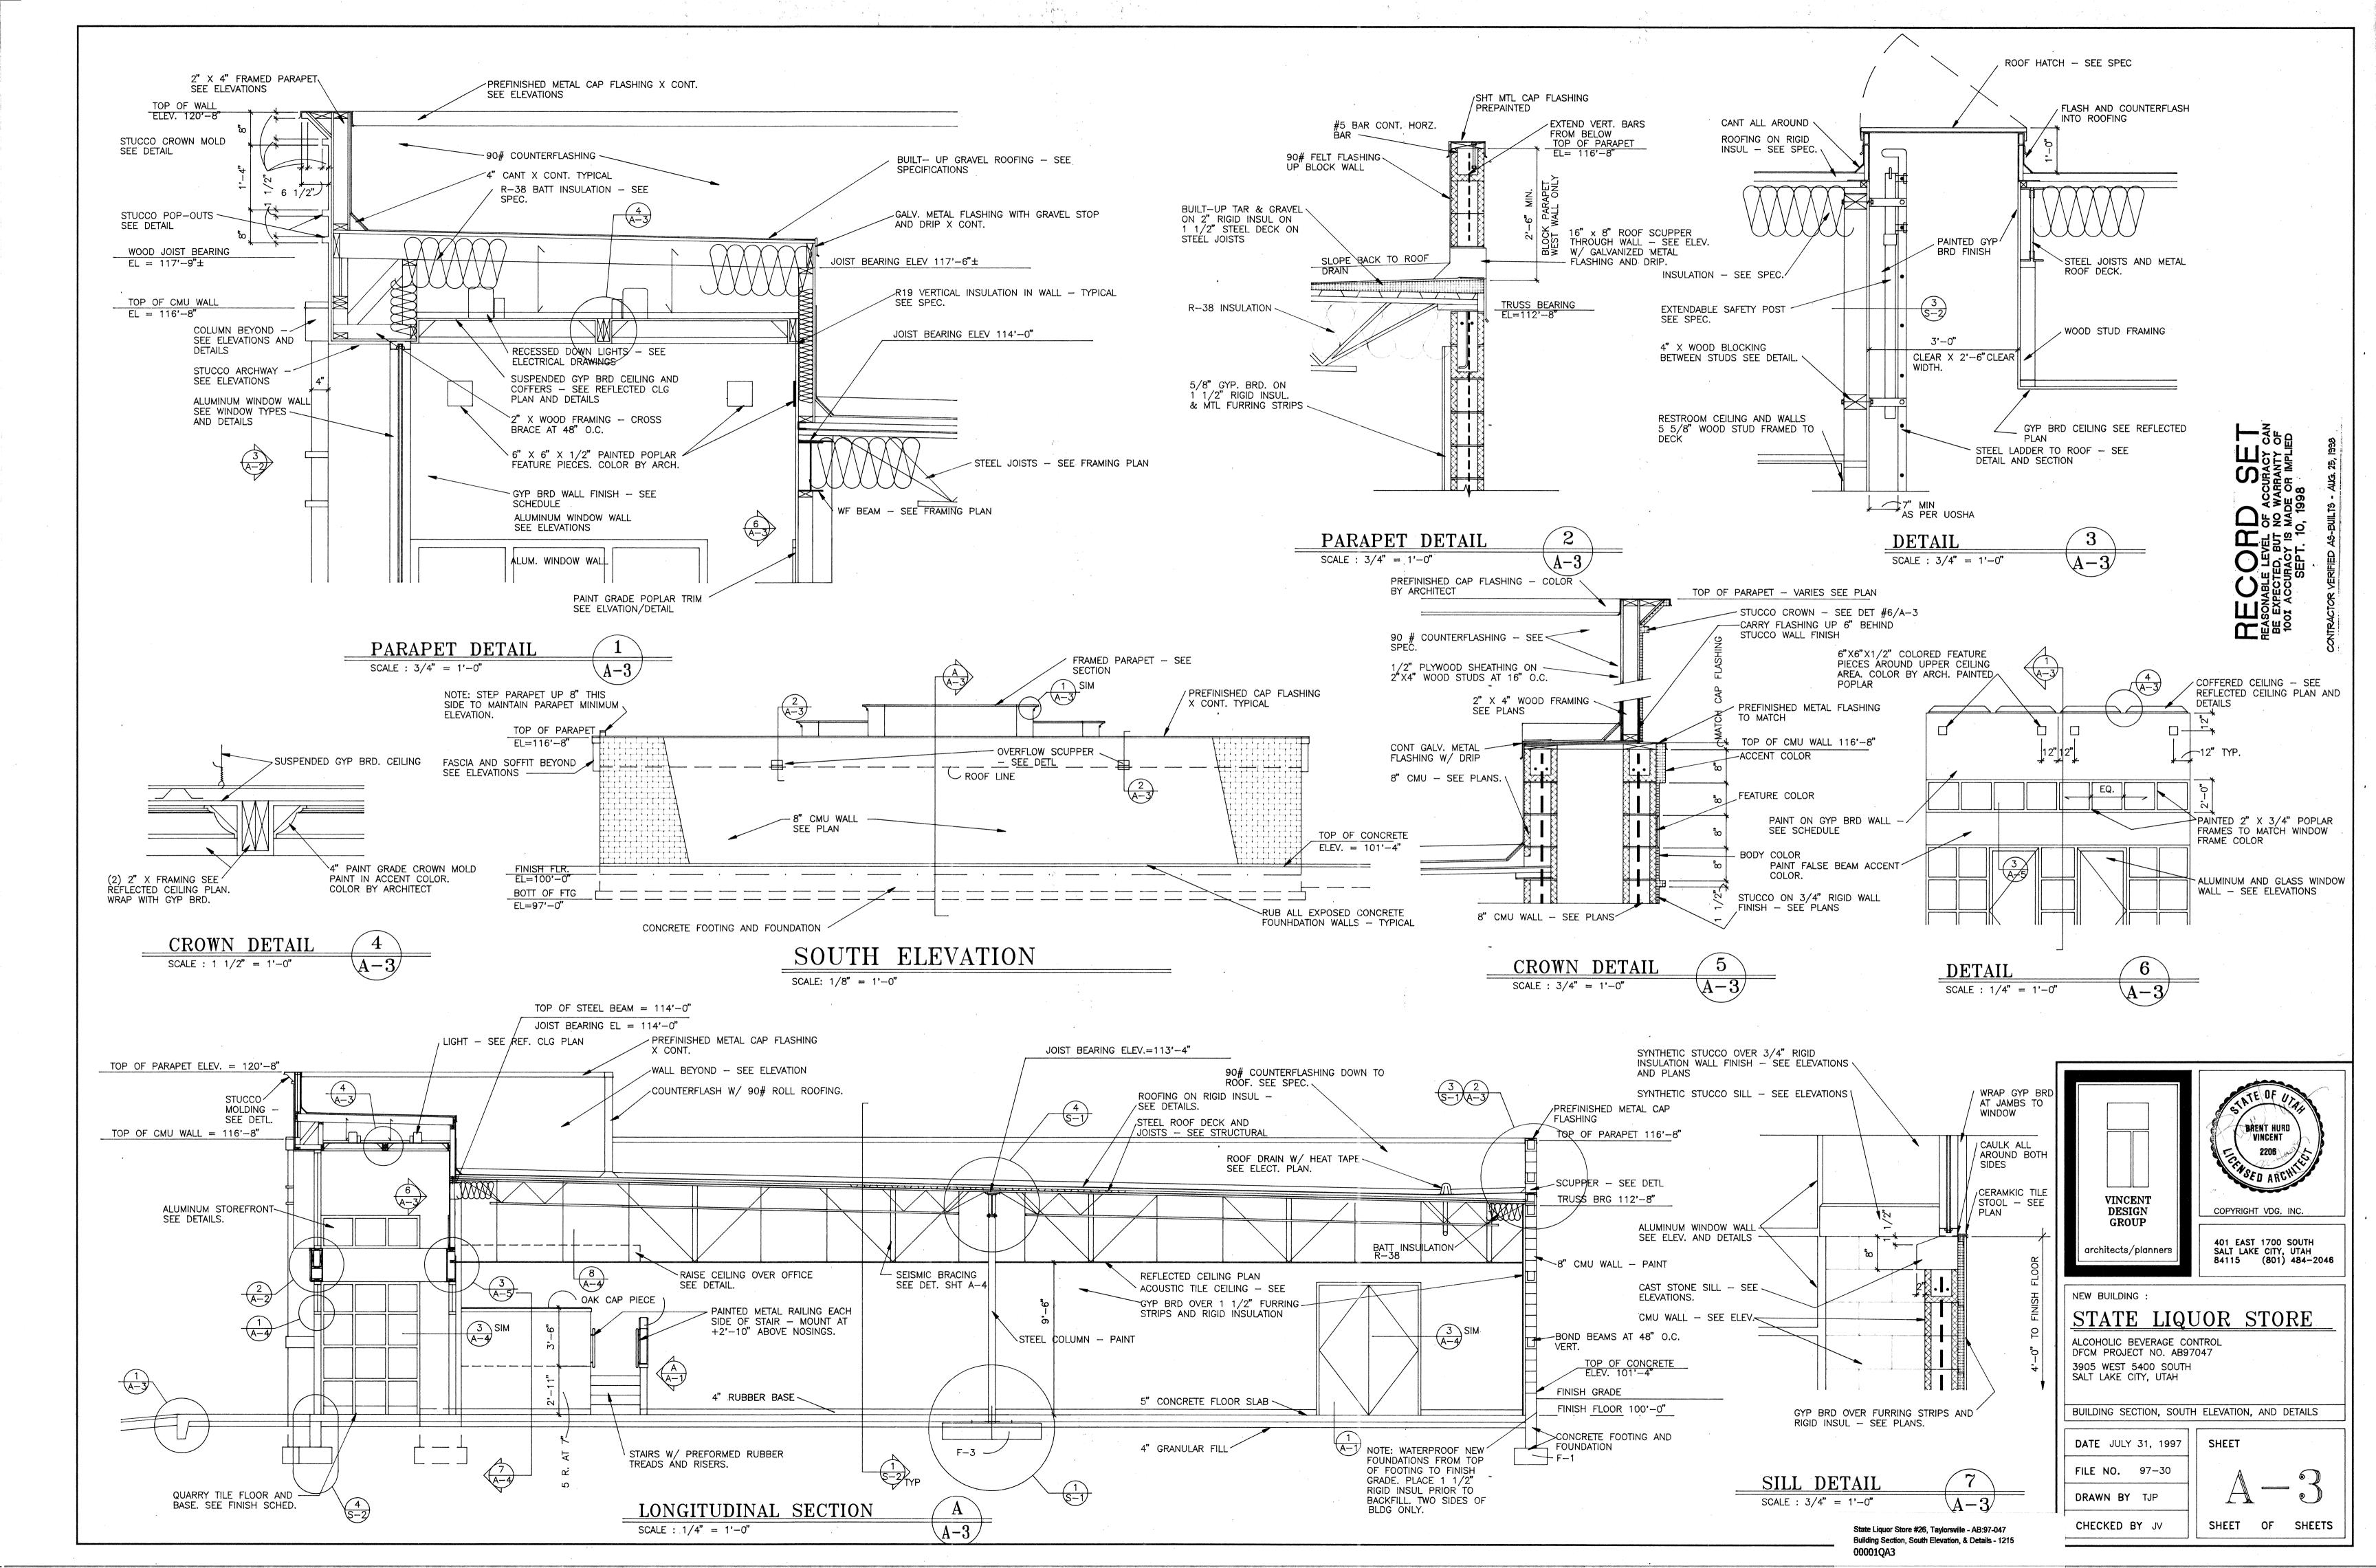

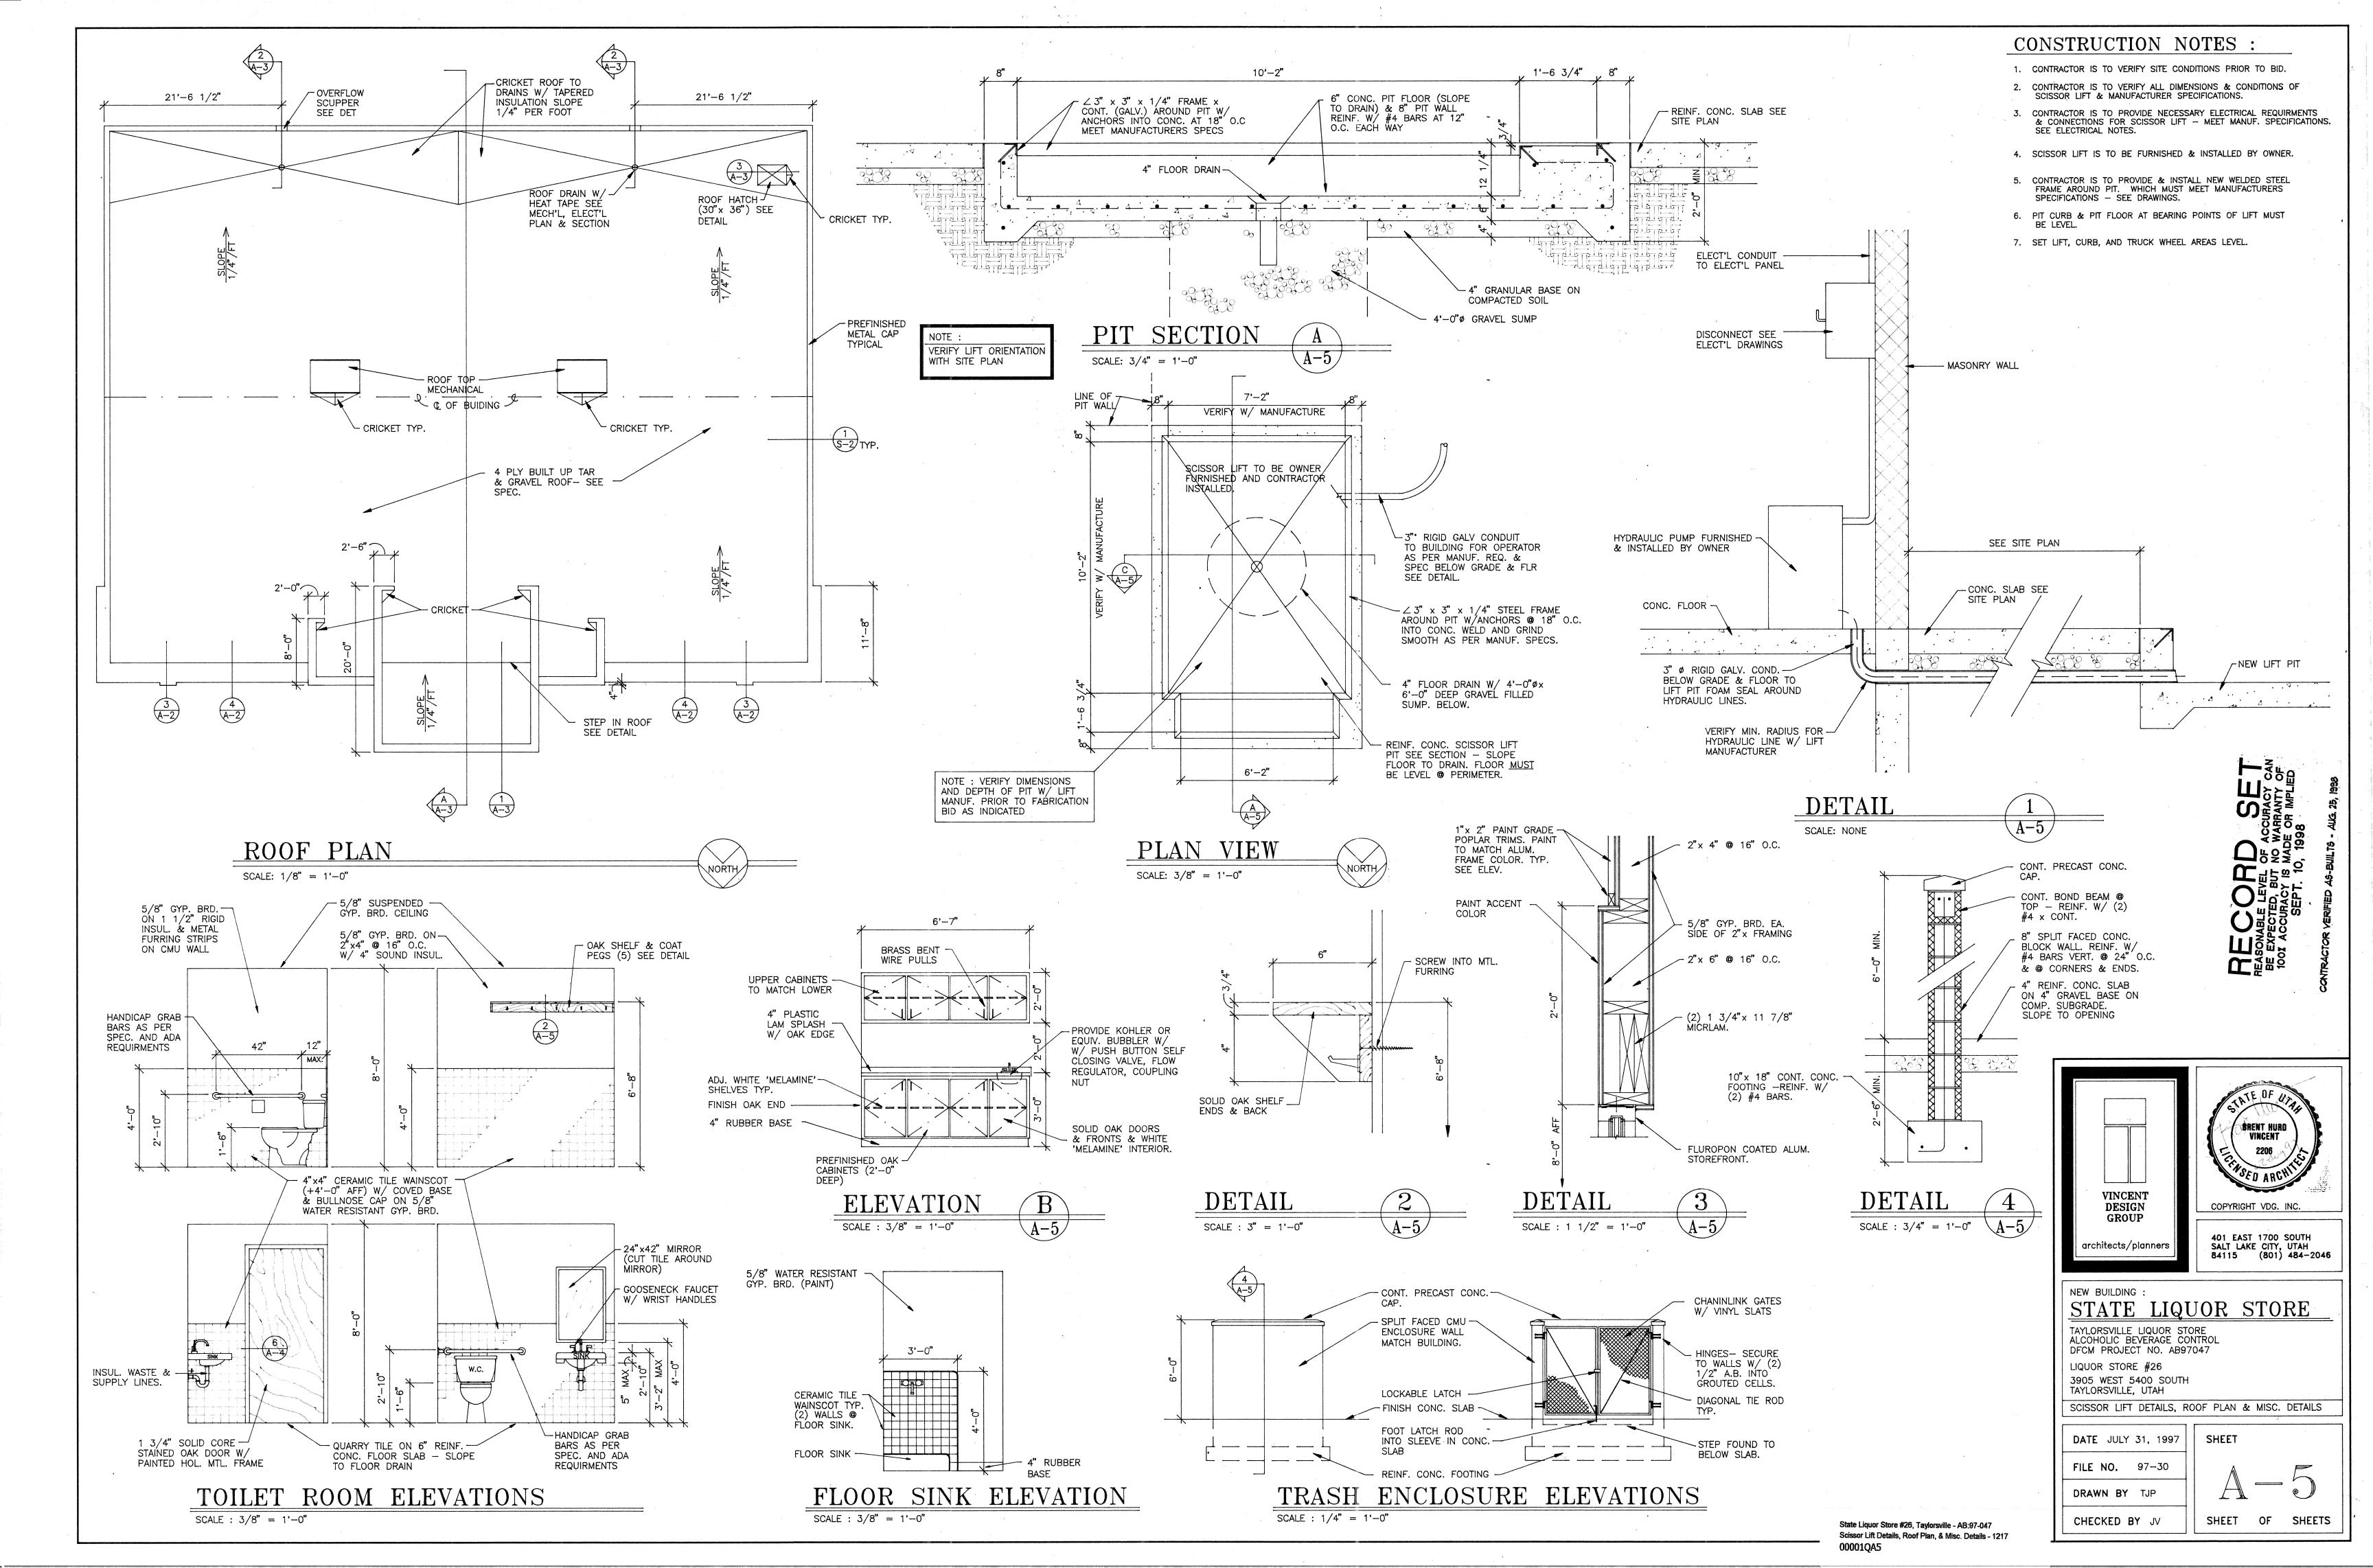


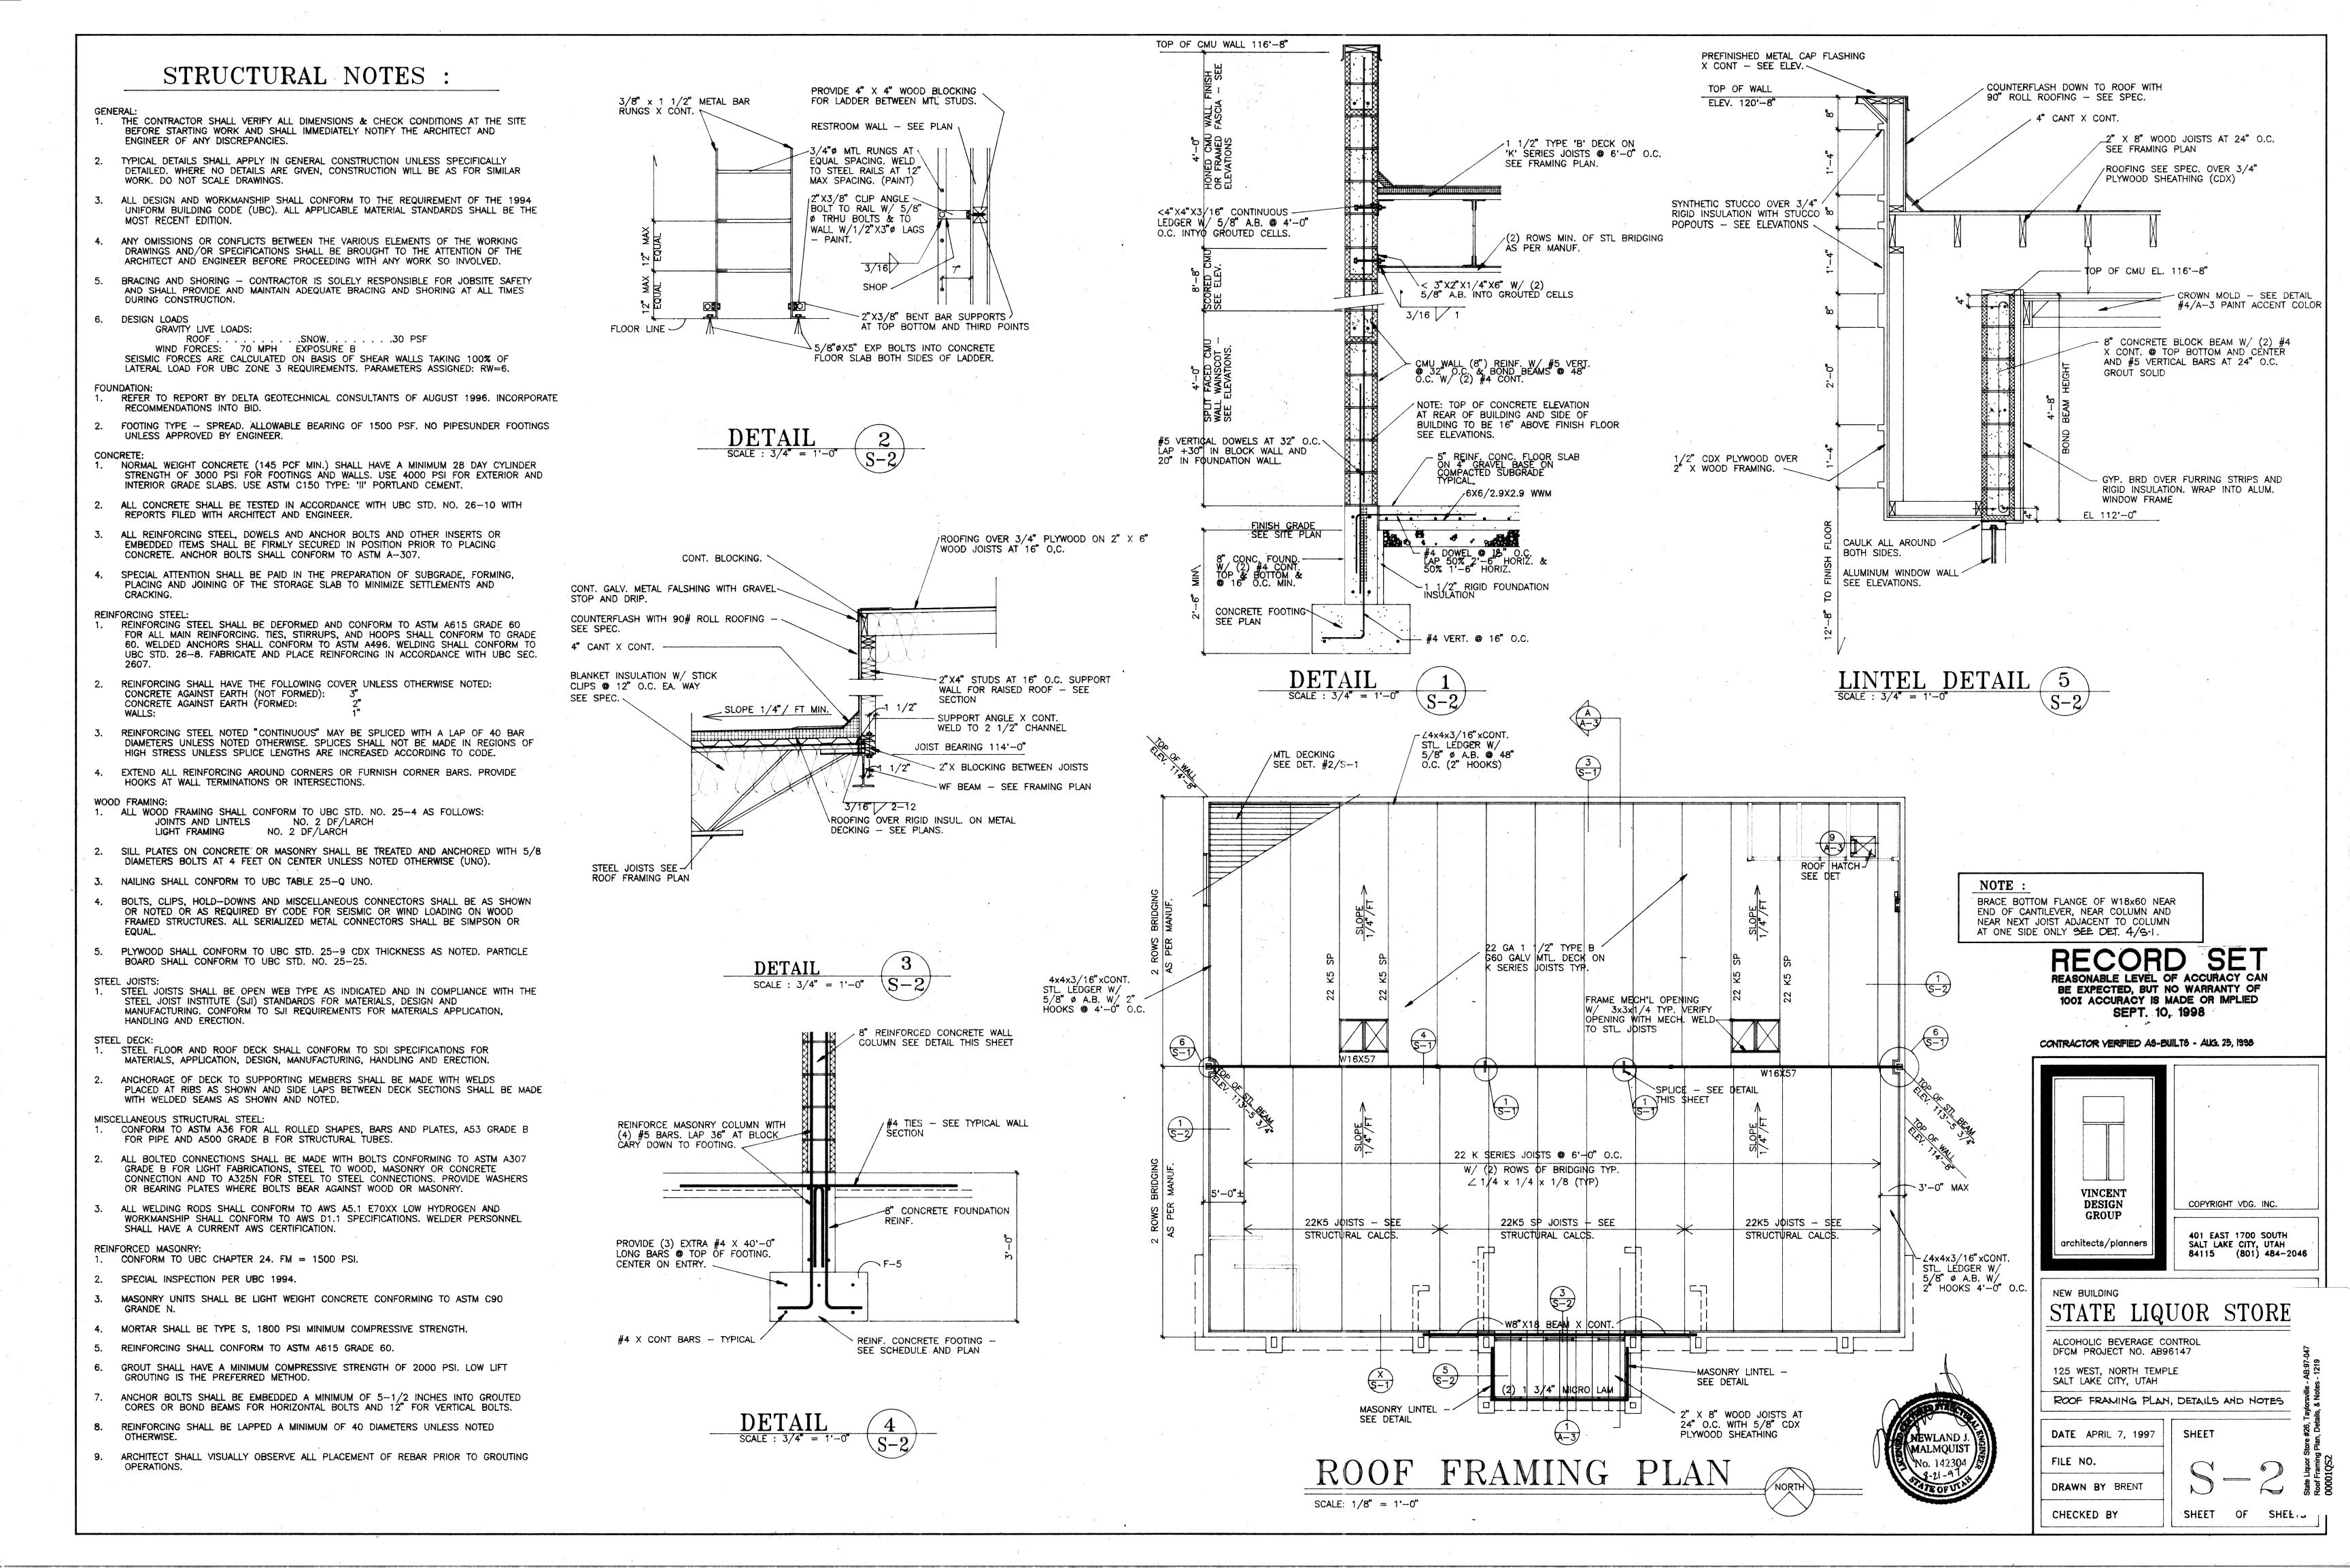

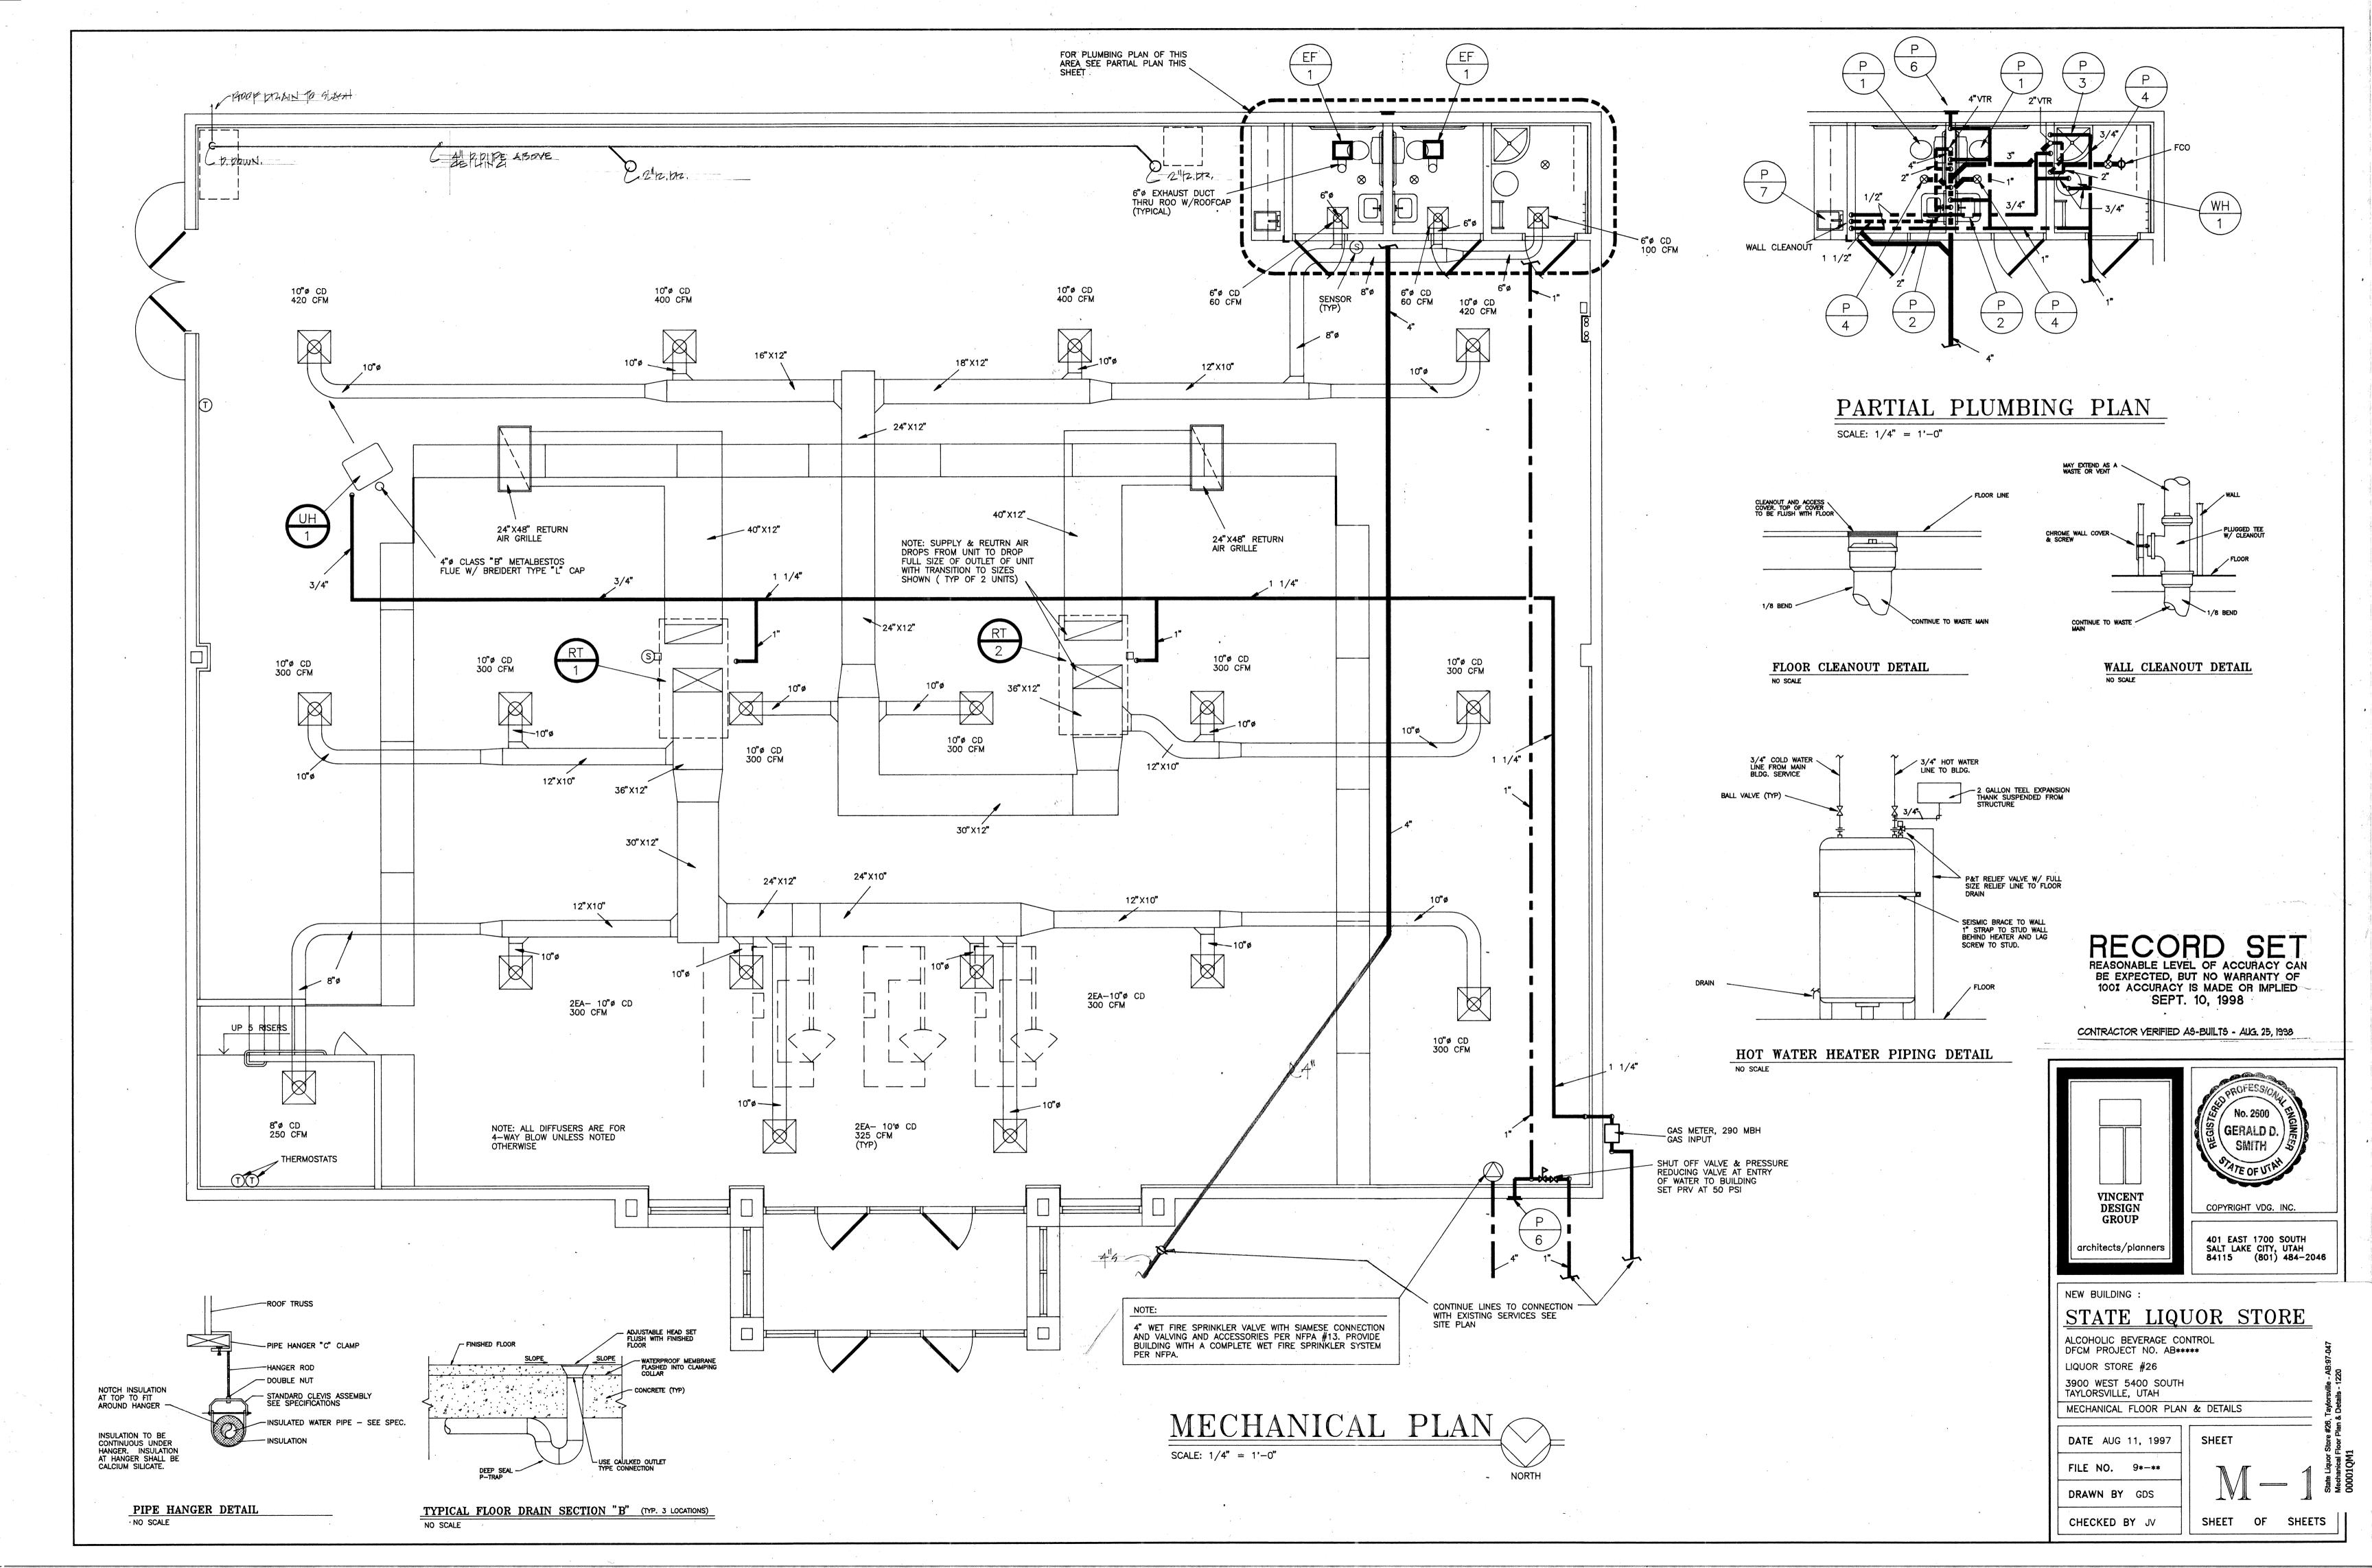

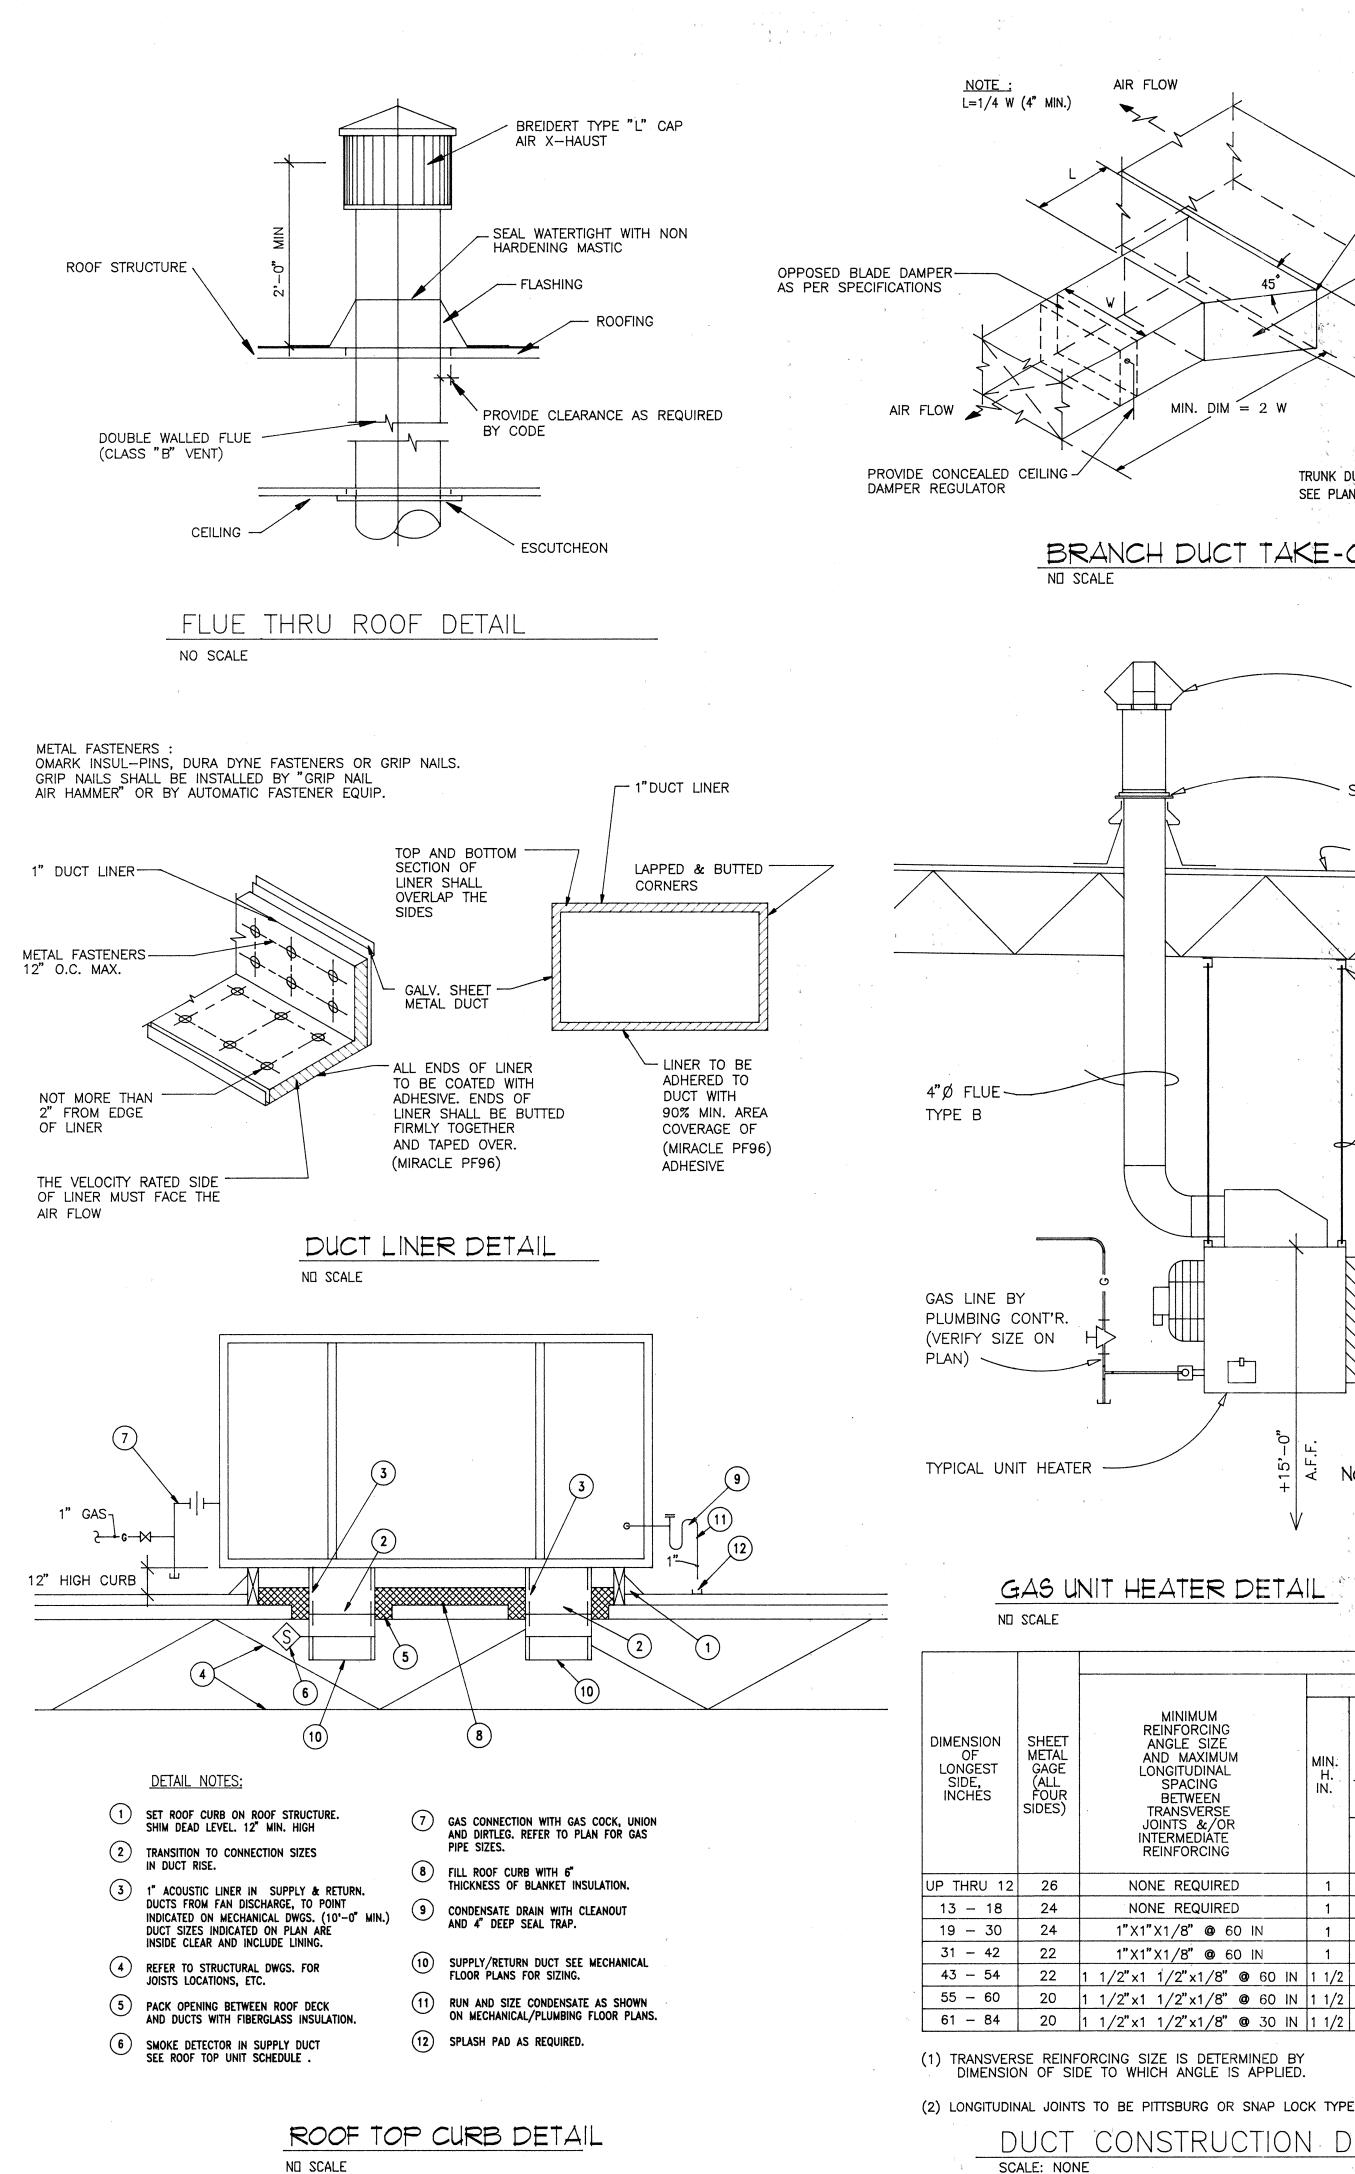

NOTE: PROVIDE REMOTE <u>NOTE :</u> L=1/4 W (4" MIN.) OPERATOR FOR **INACCESSIBLE** DAMPERS. - CLOSE OPENING AT CORNERS BRANCH DUCT PROVIDE CONCEALED CEILING TRUNK DUCT. -SEE PLANS FOR SIZE BRANCH DUCT TAKE-OFF DETAIL NO SCALE

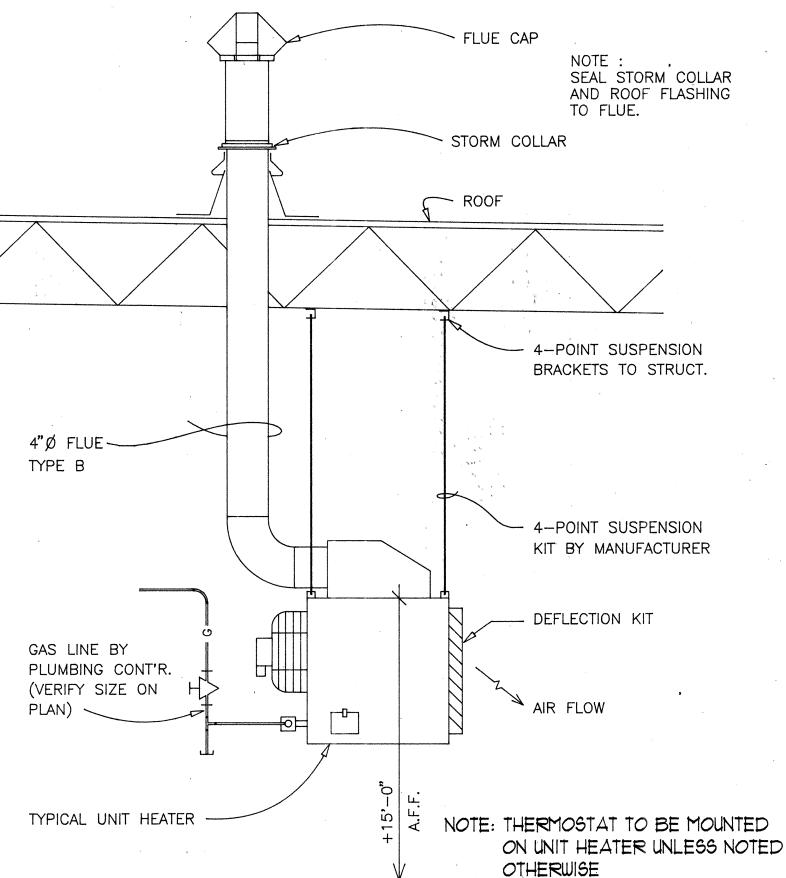

MINIMUM

REINFORCING

ANGLE SIZE

LONGITUDINAL

SPACING

TRANSVERSE

JOINTS &/OR

INTERMEDIATE

REINFORCING

NONE REQUIRED

NONE REQUIRED

1"X1"X1/8" @ 60 IN

1"X1"X1/8" @ 60 IN

CONSTRUCTION DETAIL

BETWEEN

AND MAXIMUM

DRIVE SLIP

MENDED

GAGE

26

24


26

24

SPECIFICATIONS USE #10 X 3/4" SELF TAPPING CADMIUM INSULATED SHEET -PLATED SHEET METAL SCREWS, TIGHTEN ALL METAL DUCT STRAPS AGAINST DUCT AND SUPPORT MEMBERS, (TYP.) BALANCE DAMPER WITH-LOCKING QUADRANT - HANGER STRAPS-ROUND RIGID DUCT WRAP ALL RIGID DUCT W/FDIL-FACED 1-1/2" FIBERGLASS DUCT VRAP └─ NO POP RIVETS ALLOWED FASTEN RIGID DUCT TO SPIN-IN-FITTING WITH SHEET METAL SCREWS

FLEX DUCT WITH SPIN IN FITTING


ND SCALE

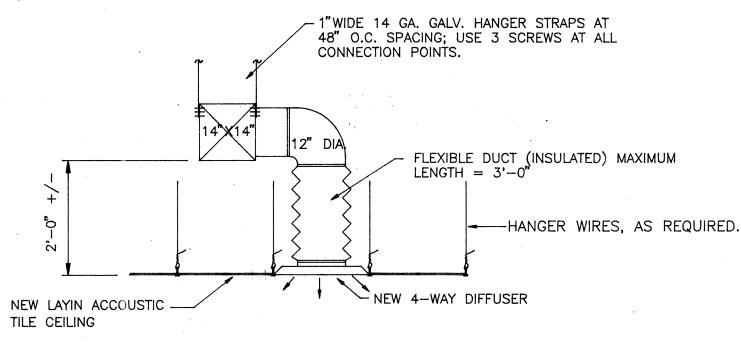

ALL SUPPLY AIR DUCT SHALL BE WRAPPED EXTERNALLY AS PER

TYPICAL DIFFUSER DETAIL

SCALE : 1/2" = 1'-0"

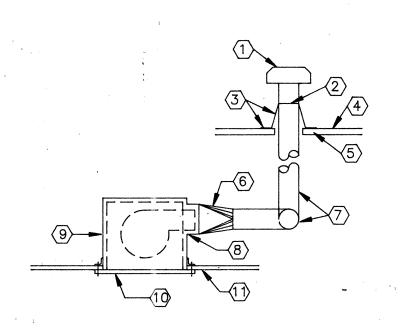

- ROOF CAP FOR FLAT ROOF
- SEAL WITH WATERPROOF CAULKING
- 3 G.I. FLASHING COLLAR 4 BUILT-UP ROOF
- (5) ROOF STRUCTURE
- TRANSITION
- ROUND DUCT (ROUTE AS SHOWN ON PLAN)
- RECTANGULAR OUTLET
- EXHAUST FAN
- 10 EXHAUST FAN OUTLET (1) CEILING LINE

EXHAUST FAN DETAIL

POCKET LOCK

POCKET LOCK

ANGLE SIZE

NOT REQ.

NOT REQ.

NOT REQ.

24 NOT REQ.

22 NOT REQ.

22 NOT REQ.

STAND. SEAM ANGLE REINFORCED

REINFORCED RECOM- REINFORCED

MENDED

GAGE

24

24

22

SCALE : NONE

Ŋŧн

STAND. SEAM

ŊH

ANGLE SIZE

NOT REQ.

NOT REQ.

NOT REQ.

NOT REQ.

NOT REQ.

NOT REQ.

TRANSVERSE REINFORCING (1)

ANGLE SLIP

ANGLE SIZE

NOT REQ.

NOT REQ.

NOT REQ.

NOT REQ.

NOT REQ.

NOT REQ.

AT JOINTS

GAGE

24

24

24

22

22

22

REIN-

RECOM- RECOM- RECOM- REINFORCED MENDED MENDED MENDED ANGLE

GAGE

24

24

22

22

22

HEMMED ALTER'NT FORCED

S SLIP BAR SLIP BAR SLIF

GAGE


24

24

24

22

22

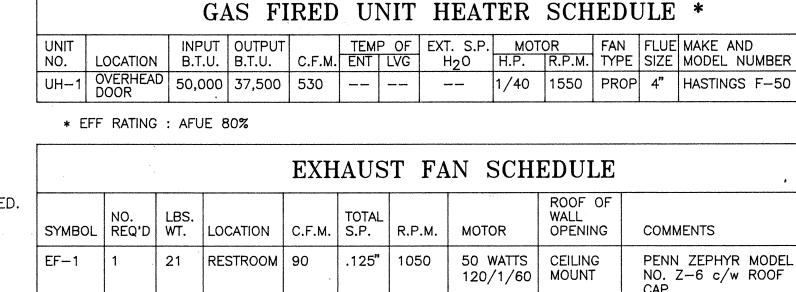

HANGER SIZES FOR

RECTANGULAR DUCT

36" 1/4" ROUND | 1 1/2"x1 1/2"x1/2" | 8'-0"

2"x2"x1/8"

CFM EXT | COOLING | HEAT | HEAT | UNIT

MBH

30" |1"x18" GAGE | NONE REQUIRED

60" 3/16" ROUND 2"x2"x1/8"

84" 3/8" ROUND 2"x2"x1/8"

STAP

ROD

ROD

ROD

ROD

48" 1/4" ROUND

HORIZONTAL MAX SUPPORT ANGLE SPACING

10'-0**"**

8'-0"

8'-0"

INPUT OUTPUT WEIGHT

1

MBH MBH

1

SYMBOL

RG-1

SIZE

SYMBOL | SIZE | BLOW | TYPE

D-1 | 10"ø | 3 WAY | SUPPLY

D-2 8"ø 4 WAY SUPPLY

D-3 8"ø 4 WAY SUPPLY

D-4 8"ø 4 WAY SUPPLY

ROOFTOP HEATING COOLING UNIT

NOTES: 1 AT SEA LEVEL 2 TRANE MODEL NO. YCDO90C3M4AWL, EER 9.0 EFF RATING AFUE 81% MIN.

RT-1,RT-2 3000 1.00" 92.0 | 120 | 97 | 1,000 | 1 | 7.5 | 27.0 | 164 | 1 | 0.5 | 3.4 | 1 | 2.0 | 8.8 | 46.0 | 60 | -- | 208 | 3 | 60

FACTORY INSTALLED SMOKE DETECTORS SHALL BE PROVIDED & CONNECTED PER UMC

D-5 6"ø 3 WAY SUPPLY

ELECTRICAL CHARACTERISTICS

#|HP|RLA|LRA|#| HP| FLA |#| HP| FLA|

COMPRESSOR OUTDOOR FAN INDOOR FAN AMP AMP

22"x22" | RETURN

	,	PLU	MBIN	G FIX	TURE	SCH	EDUL	E
LEGEND	SYMBOL	FIXTURE	WASTE	VENT	TRAP	C.W.	H.W.	COMMENTS
P-1	0[]	WATER CLOSET	4"	2"	4"	1/2"		
P-2		HAND SINK	1 1/2"	1 1/2"	1 1/2"	1/2"	1/2"	* ·
P-3		SERVICE SINK	3"	2"	3"	3/4"	3/4"	FLOOR TYPE
P-4	8	FLOOR DRAIN	2"	2"	2"			
P-5		NOT USED						
P-6	-+ `	HOSE BIBB				3/4"		FREEZE-PROOF
P-7	П	BREAK SINK	2"	1 1/2"	1 1/2"	1/2"	1/2"	W/ WATER SPOUT FOR DRINKING WATER
WH-1	00	WATER HEATER				3/4"	3/4"	ELECTRIC INPUT 20 GAL 2 KW 208/1/60

REGISTER AND GRILLE SCHEDULE

DIFFUSER SCHEDULE

TYPE

C.F.M. RANGE

2100

C.F.M. RANGE

275

COMMENTS

TITUS TXP 24"x24"

COMMENTS

TITUS TMS 24" X 24"

TITUS TMS $24" \times 24"$ TITUS TMS 24" x 24"

TITUS TMS 24" X 24"

TITUS TMS 12" x 12"

MIN | MAX | DUEL | VOLTS | O | HZ

COMMENTS

PENN ZEPHYR MODEL

NO. Z-6 c/w ROOF

FUSE

ROOF OF

OPENING

CEILING

MOUNT

- ① WATER HEATER MUST MEET REQUIREMENTS OF ENERGY CODE AND SUPPLY TEMPERATURE TO BE SET AT 105° F. MIN. EFF.
- ② MINIMUM WASTE LINE SIZE BELOW GRADE TO BE 2"

LEGEND					
SYMBOL	DESCRIPTION				
VD VD	BRANCH DUCT TAKE-OFF	*			
France	BRANCH DUCT TAKE-OFF				
TANANA E E E E E E E E E E E E E E E E E	DUCT TEE CONNECTION				
	ROUND TO RECTANGULAR DUCT TRANSITION	•			
VD	OPPOSED BLADE VOLUME DAMPER W/ CONCEALED CEILING DAMPER REQULATOR				
\bigcirc	THERMOSTAT				

RECORD REASONABLE LEVEL OF ACCURACY CAN BE EXPECTED, BUT NO WARRANTY OF 100% ACCURACY IS MADE OR IMPLIED SEPT. 10, 1998

CONTRACTOR VERIFIED AS-BUILTS - AUG. 25, 1998

VINCENT DESIGN GROUP 401 EAST 1700 SOUTH architects/planners SALT LAKE CITY, UTAH 84115 (801) 484-2046

NEW BUILDING STATE LIQUOR STORE


ALCOHOLIC BEVERAGE CONTROL DFCM PROJECT NO. AB LIQUOR STORE #26 3900 WEST 5400 SOUTH

TAYLORSVILLE, UTAH MECHANICAL DETAILS AND SCHEDULES


DATE AUG 11, 1997 SHEET FILE NO. 97-XX DRAWN BY GDS CHECKED BY JV

SHEET OF SHEETS

22 22 | 1 1/2x1 1/2x1/8 | 1 1/2x1 1/2x1/8 | 22 | 1 1/2x1 1/2x1/8 | 20 | 1 1/2"x1 1/2"x1/8" @ 30 IN | 1 1/2 (1) TRANSVERSE REINFORCING SIZE IS DETERMINED BY DIMENSION OF SIDE TO WHICH ANGLE IS APPLIED. (2) LONGITUDINAL JOINTS TO BE PITTSBURG OR SNAP LOCK TYPE.

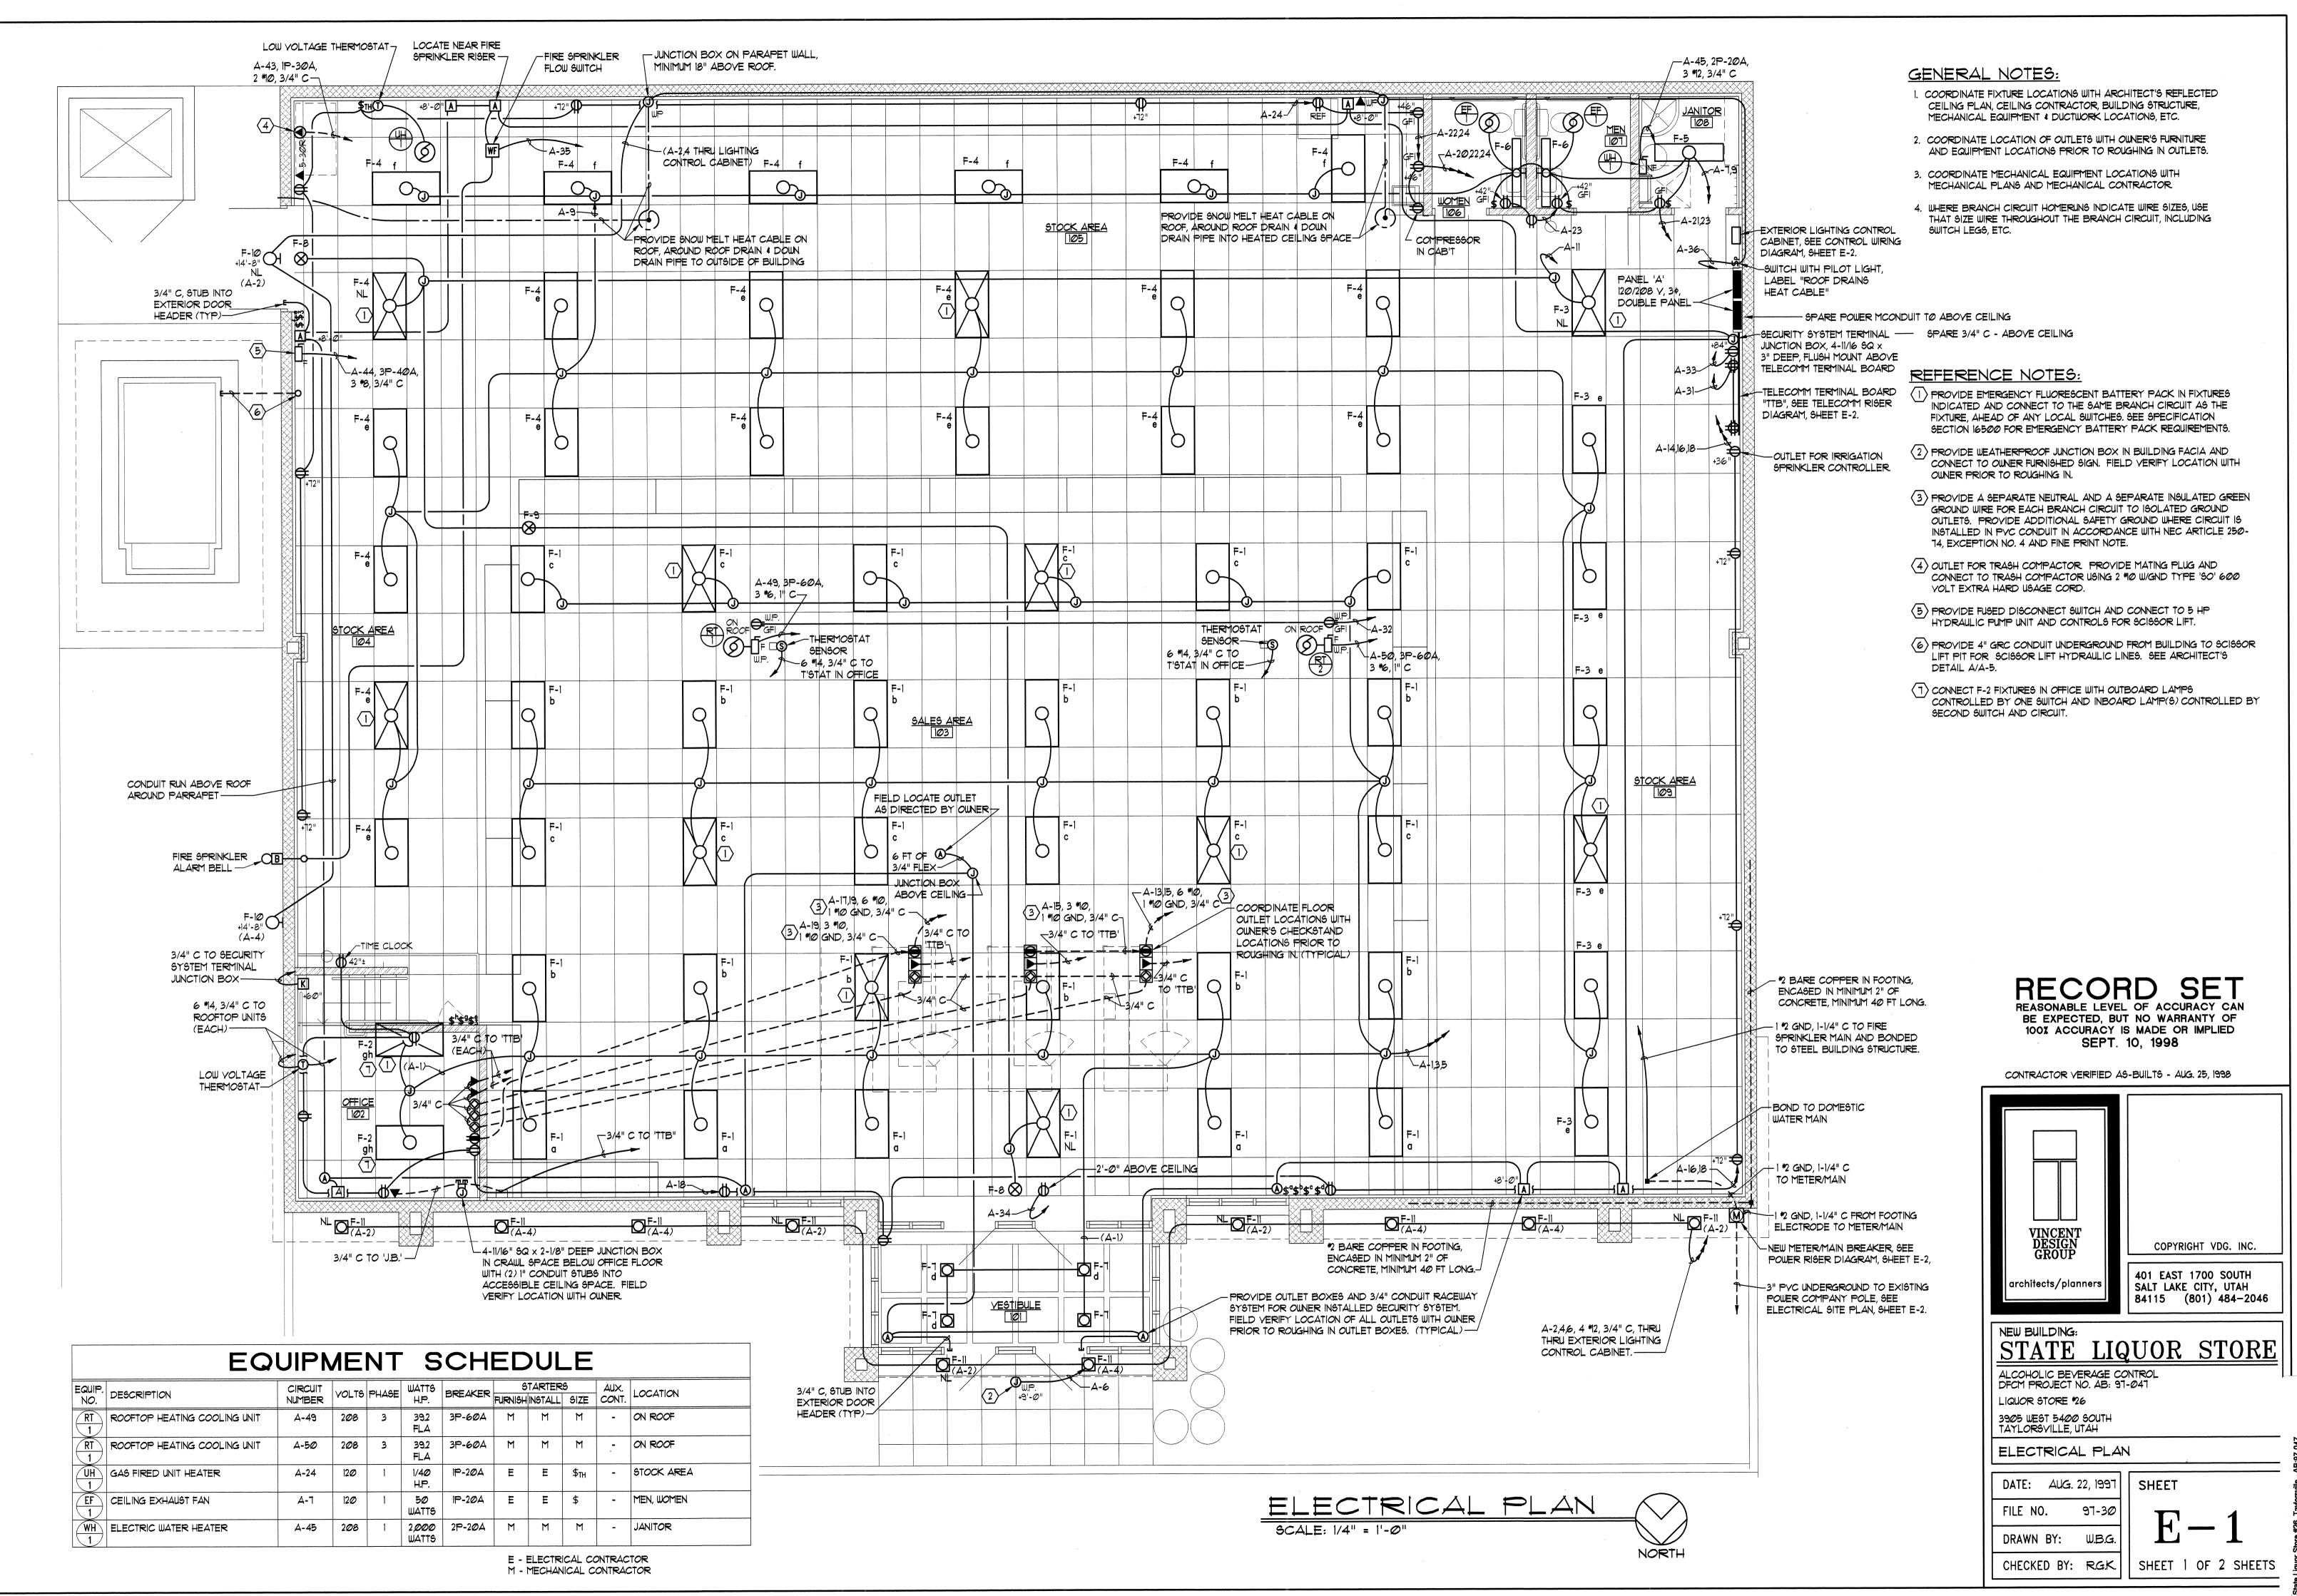


Glade Liqued State #222 Electrical Plan - 1222 00001QE1

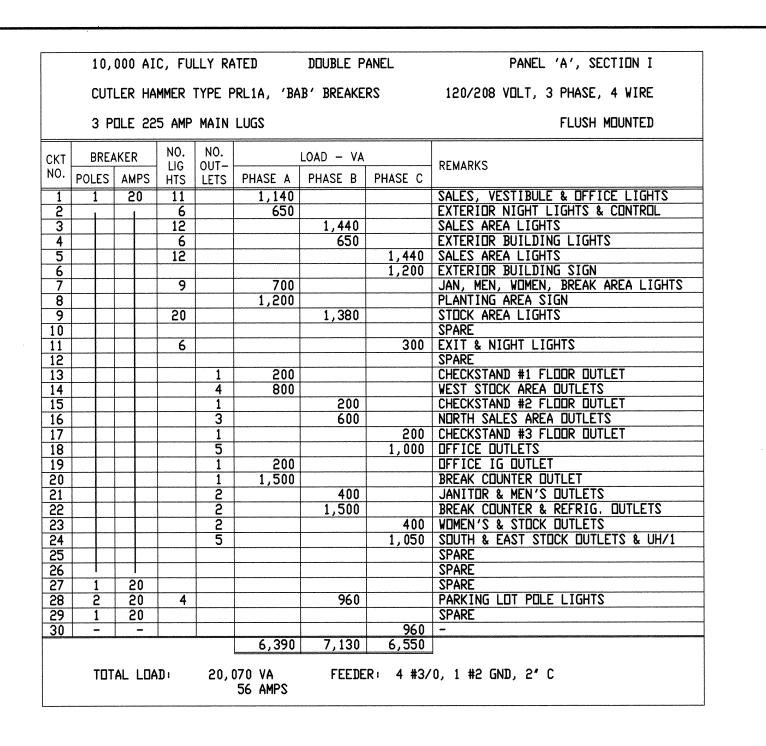

		AKER	E 225 AMP MAIN LUGS			_OAD - VA		FLUSH MOUNTED		
CKT NO.			LIG	OUT-				REMARKS		
	POLES		HTS	LETS		PHASE B	PHASE C	TELECOMA BEADD BUTLETO		
31	1	20		4 2	800 400			TELECOMM BOARD OUTLETS OUTLETS ON ROOF		
32 33				1	400	200		SECURITY SYSTEM DUTLET		
33 34				1		200		DUTLET ABOVE CEILING @ FRONT		
35	1	20		 		200	200	FIRE SPRINKLER ALARM BELL		
36	1	*20					800	ROOF DRAINS HEAT CABLE		
37	i	20						SPARE		
38	1	1						SPARE		
39								SPARE		
40								SPARE		
41		ı						SPARE		
42	1	20						SPARE		
43	1	30		1	2,000			TRASH COMPACTOR		
44	3	40			2,100	4 000		HYDRAULIC SCISSOR LIFT		
45	2	20		ļ		1,000		ELECTRIC WATER HEATER WH/1		
46	_	-		-		2,100	1 000	-		
47		_					1,000 2,100	<u>-</u>		
48 49	3	60		-	4,705		2,100	EAST ROOFTOP UNIT RTU/1		
50	3	60			4,705			WEST ROOFTOP UNIT RTU/2		
51	-	-			7,703	4,705		- WEST KEET TEL CHIT KTO/E		
52		_		-		4,705		-		
53			-	<u> </u>		.,,,	4,705	-		
54	-	_		1			4,705			
55	1			 				SPACE		
56	 		l	1				1		
57										
58										
59										
60	1							SPACE		
	SECTION II 14,710 12,910 13,51									
	SECTIONS I & II 21,100 20,040 20,060									

* PROVIDE BREAKER FOR SNOW MELT HEAT CABLE WITH 30 MA EQUIPMENT GROUND FAULT PROTECTION.

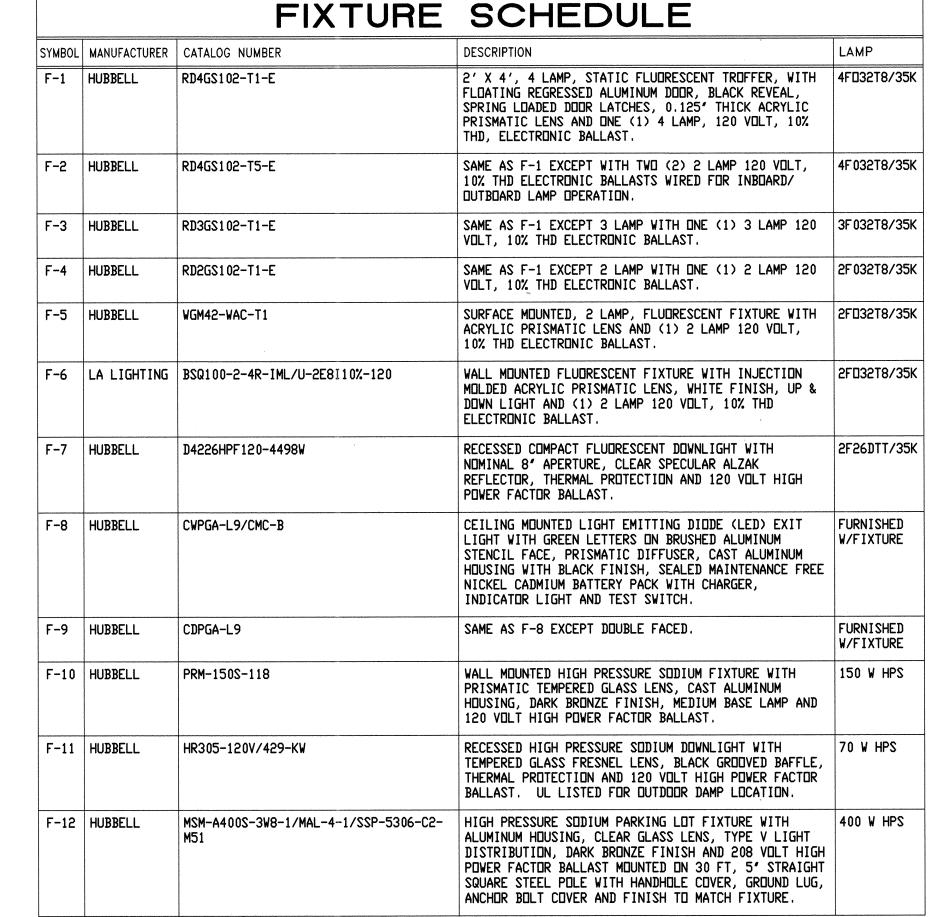

1. REFER TO SPECIFICATION SECTION 16500 FOR ADDITIONAL FIXTURE REQUIREMENTS INCLUDING ELECTRONIC BALLAST REQUIREMENTS AND ACCEPTABLE BALLAST MANUFACTURERS.

EXTERIOR LIGHTING CONTROL EQUIPMENT:

- CBI CONTROL CIRCUIT BREAKER, 120 VOLT, 5 AMP THERMAL MAGNETIC TRIP, RAIL MOUNTED: SQUARE D CLASS 9080, TYPE GCB50. INSTALL IN CABINET.
- SSI SELECTOR SWITCH, 3 POSITION, MAINTAINED CONTACT, 2 N.Ø. & 2 N.C. CONTACTS: SQUARE D CLASS 9001, TYPE KS43BH2 WITH 9001-KN360 "HAND-OFF-AUTO" ALUMINUM LEGEND PLATE. INSTALL IN COVER OF CABINET.
- PCI PHOTOCELL, 2000 WATT, 120 YOLT, WITH SPST CONTACTS: TORK 12101 OR EQUAL. INSTALL OUTSIDE FACING NORTH.
- TSI TIME SWITCH, 120 YAC, ELECTRONIC WITH BATTERY BACKUP, 5 AMP SPST: INTERMATIC MODEL ETTIS-C OR EQUAL. INSTALL ADJACENT TO CABINET.
- LCI LIGHTING CONTACTOR, ELECTRICALLY HELD, 6 POLE 20 AMP, 120 YAC COIL: SQUARE D CLASS 8903, TYPE LOGO-YOZ OR EQUAL. INSTALL IN CABINET.
- LC2 LIGHTING CONTACTOR, ELECTRICALLY HELD, 4 POLE 20 AMP, 120 YAC COIL: SQUARE D CLASS 8903, TYPE LO40-Y02 OR EQUAL. INSTALL IN CABINET. LIGHTING CONTROL CABINET, 12" W x 16" H x 6" D, NEMA 1 ENCLOSURE WITH

HINGED FRONT COVER, FLUSH LATCH AND EQUIPMENT MOUNTING PANEL:

WIEGMAN *NIC-121606 OR EQUAL. TERMINAL BLOCKS: 600 VOLT, FOR \$22-8 CONDUCTORS, PROVIDE WITH MOUNTING RAIL, END BARRIERS, ETC., AS REQUIRED: SQUARE D CLASS 9080, TYPE GR6 OR EQUAL. INSTALL IN CABINET AS REQUIRED FOR TERMINATION OF

CONTROL NOTES:


1. USE MINIMUM #14 STRANDED WIRE FOR ALL CONTROL CONDUCTORS. LABEL WIRE ACCORDING TO NUMBER ON CONTROL DIAGRAM. SEE SPECIFICATION

ALL CONDUCTORS TO OUTSIDE OF CABINET


- 2. REFER TO ELECTRICAL PLANS FOR POWER WIRE SIZES. LABEL POWER WIRING ACCORDING TO CIRCUIT NUMBER.
- 3. PROVIDE ENGRAYED NAMEPLATE FOR "EXTERIOR LIGHTING CONTROL CABINET" IN ACCORDANCE WITH SPECIFICATION SECTION 16195. PROVIDE SELF-ADHESIVE LABEL TO INCLUDE CIRCUIT NUMBERS OF ALL CONTROL AND
- 4. PROVIDE SELF-ADHESIVE LABELS TO IDENTIFY ALL CONTROL DEVICES ACCORDING TO WIRING DIAGRAM.

SCHEMATIC

5. PROVIDE DEVICES AS SPECIFIED OR EQUAL OF ACCEPTABLE MANUFACTURERS LISTED IN SPECIFICATION SECTION 16480.

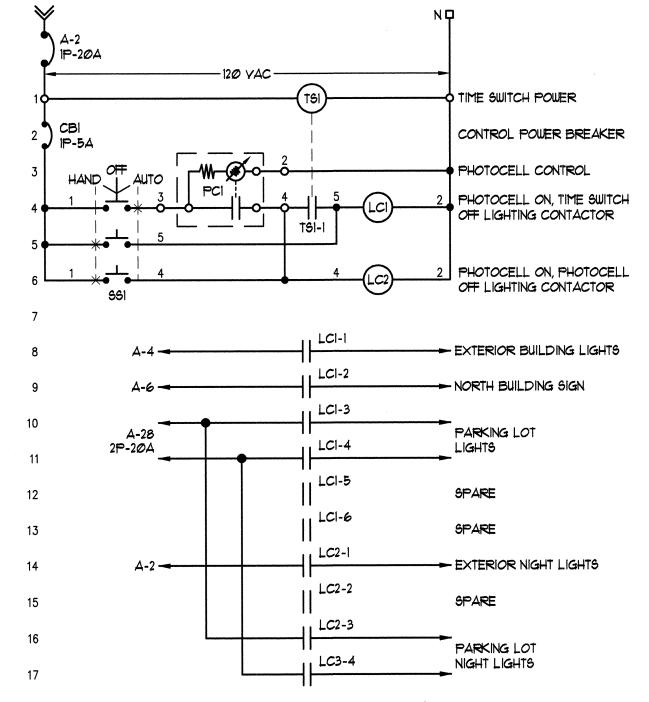



EXTERIOR LIGHTING CONTROL WIRING DIAGRAM

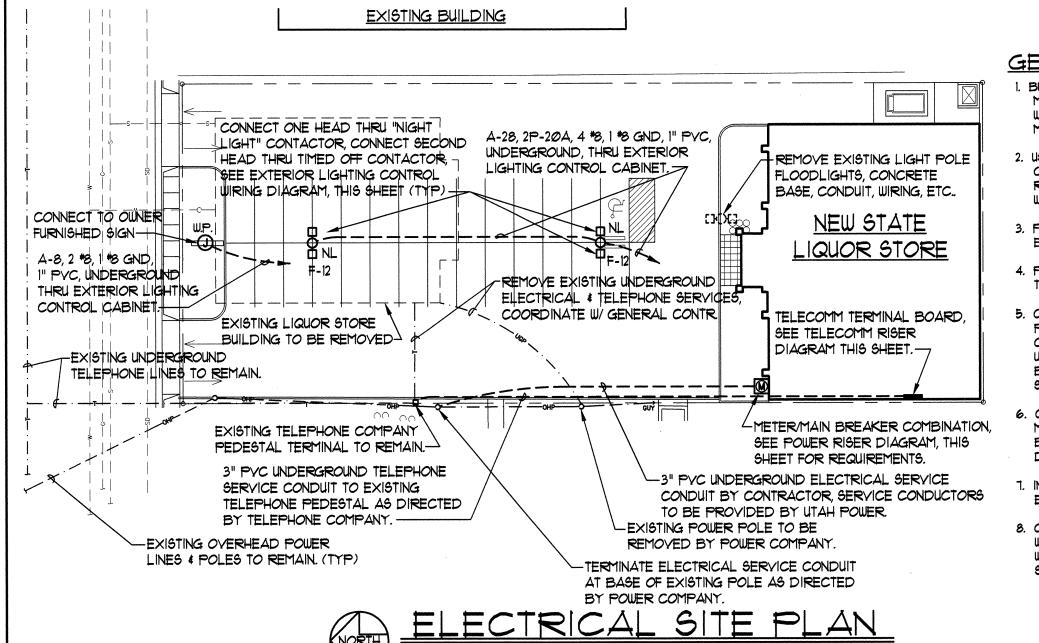

GENERAL SITE NOTES

- . BURY ALL UNDERGROUND CONDUITS OUTSIDE OF BUILDING MINIMUM 24" BELOW FINISH GRADE WITH RED MAGNETIC WARNING TAPE STATING "CAUTION - BURIED ELECTRICAL" MAXIMUM 12 INCHES ABOVE EACH CONDUIT.
- . USE GALYANIZED RIGID STEEL CONDUIT (GRC) FOR ALL CONDUIT THROUGH GRADE AND ELBOWS IN PVC CONDUIT RUNS. CORROSION PROTECT GRC CONDUIT IN ACCORDANCE WITH THE SPECIFICATIONS.
- 3. PROVIDE MINIMUM 36" RADIUS GRC ELBOWS FOR NEW ELECTRICAL AND TELEPHONE SERVICE CONDUITS.
- 4. PROVIDE 1/4" NYLON PULL ROPE IN NEW ELECTRICAL AND TELEPHONE SERVICE CONDUITS.
- 5. COORDINATE ELECTRICAL SITE WORK WITH GENERAL SITE PLAN, SHEET C-1, GENERAL CONTRACTOR, MECHANICAL CONTRACTOR AND LANDSCAPING CONTRACTOR. INSTALL UNDERGROUND CONDUITS SUCH THAT CONDUITS WILL NOT BE DAMAGED BY SUBSEQUENT INSTALLATION OF TREES AND
- 6. COORDINATE INSTALLATION OF ELECTRICAL SERVICE AND METERING WITH LOCAL POWER COMPANY PRIOR TO BEGINNING WORK. CONTACT UTAH POWER, SCOTT Denovellis, 974-7008.
- 7. INCLUDE \$10000 FEE FOR INSTALLATION OF UNDERGROUND ELECTRICAL SERVICE, PAYABLE TO UTAH POWER.
- 8. COORDINATE INSTALLATION OF NEW TELEPHONE SERVICE WITH LOCAL TELEPHONE COMPANY PRIOR TO BEGINNING WORK. CONTACT U.S. WEST COMMUNICATIONS, VALERIE SPROUL, 974-8140.

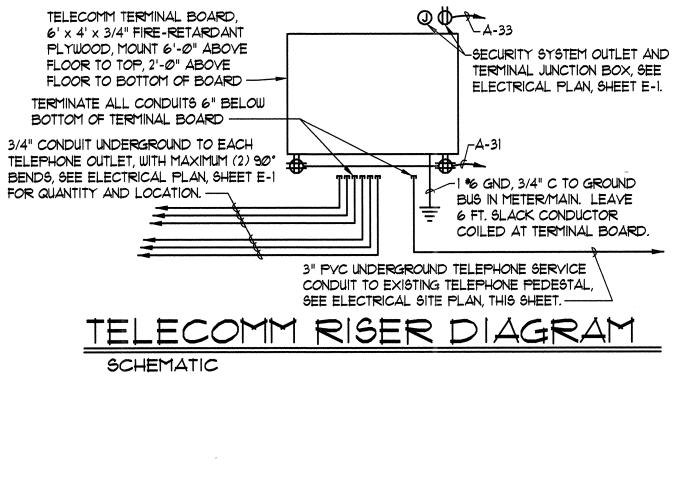

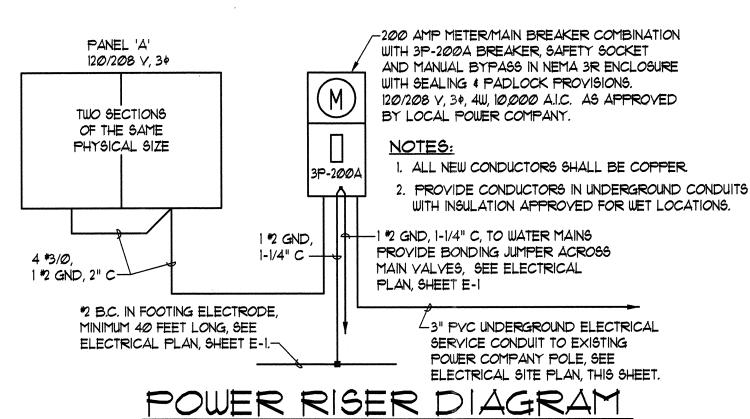


SCHEMATIC

POLE - SEE FIXTURE SCHEDULE FOR HEIGHT AND TYPE -- LIGHT FIXTURE, SEE ANCHOR BOLTS, SET ACCORDING FIXTURE SCHEDULE TO POLE MANUFACTURER'S TEMPLATE --HANDHOLE WITH COVER BASEPLATE --BREAKAWAY FUSE IN HANDHOLE SEE SPECIFICATION SECTION 16500 NON-SHRINK GROUT UNDER BASEPLATE --GROUND LUG IN HANDHOLE 3/4" x 45° CHAMFER, ALL -GROUNDING BUSHING ON EXPOSED EDGES OF ALL CONDUITS CONCRETE -ANCHOR BOLT COVERS TO BE RUBBED FINISH, ALL PROVIDED BY POLE MANUFACTURER EXPOSED CONCRETE, PAINT WHERE REQUIRED BY DIVISION 9 SPECIFICATIONS -FINISHED GRADE -UNDISTURBED EARTH OR SOLID, COMPACTED BACKFILL (TYP.)-3/4 " C ---GALVANIZED RIGID STEEL -EXOTHERMIC WELD CONDUIT THROUGH POLE BASE, CORROGION PROTECTED PER SPECIFICATION SECTION 16110 (TYP) PYC CONDUIT -STUB (1) 3/4" SPARE UNDERGROUND -CONDUIT OUT FROM EACH RIGID TO PYC POLE BASE AND MARK CONNECTOR -少十3" CLEAR LOCATION OF STUB ON 14 - 4 - 4 (TYPICAL CONCRETE POLE BASE IN TOP OF BASE, FIELD ACCORDANCE WITH DIVISION 3 VERIFY DIRECTION OF SPECIFICATIONS -STUB WITH ARCHITECT AND/OR OWNER. +3/4" x 10'-0" COPPER GROUND ROD, DRIVEN - *4 TIES AT 8" ON FULL LENGTH INTO EARTH CENTER WITH 3 IN TOP 8" OF BASE --4 % VERTICAL REBAR 2'-Ø" DIA

TYPICAL POLE BASE DETAIL

NOT TO SCALE

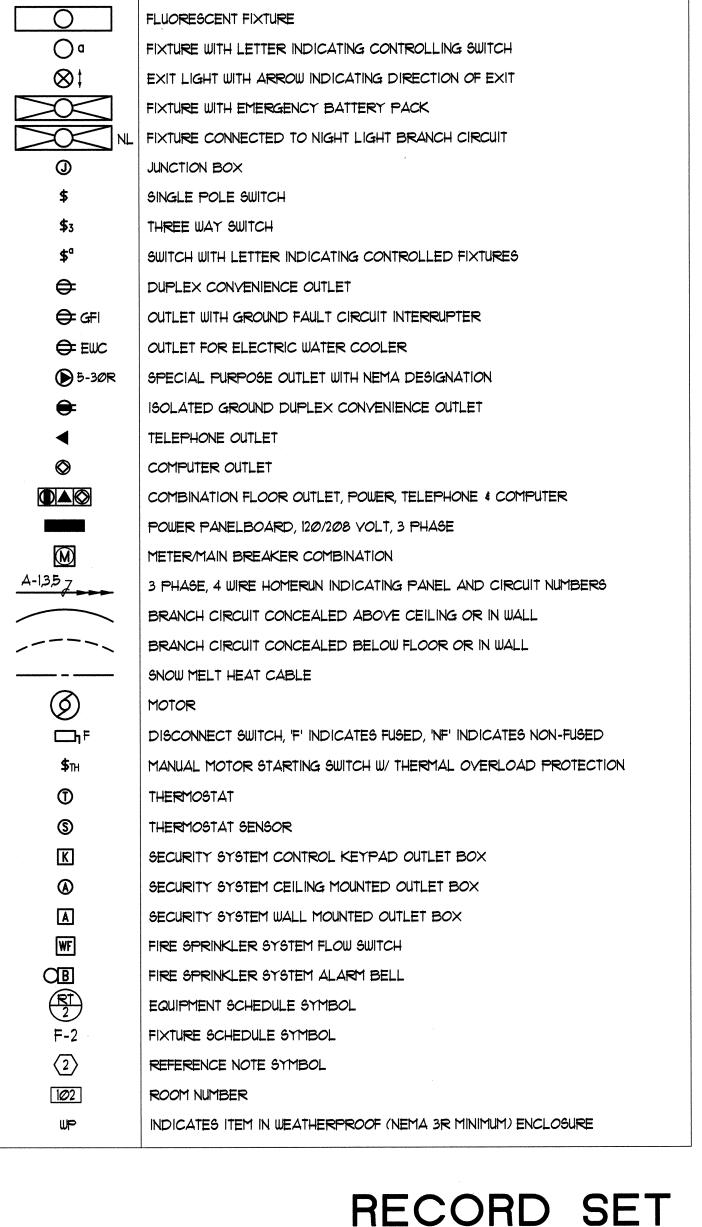

SYMBOL LIST

DESCRIPTION


CEILING MOUNTED FIXTURE

WALL MOUNTED FIXTURE

SYMBOL

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BE EXPECTED, BUT NO WARRANTY OF

STATE LIQUOR STORE

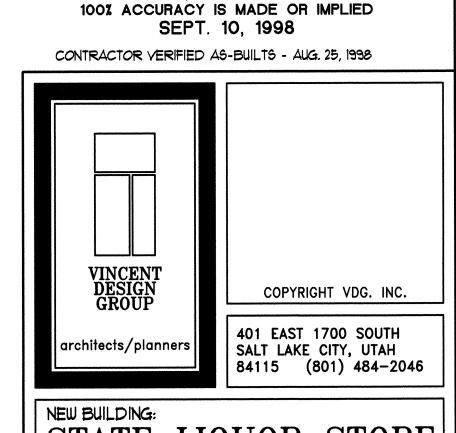ALCOHOLIC BEVERAGE CONTROL DFCM PROJECT NO. AB: 91-047

LIQUOR STORE *26

3905 WEST 5400 SOUTH TAYLORSYILLE, UTAH ELECTRICAL SITE PLAN, SCHEDULES & RISERS

DATE: AUG. 22, 1997 97-30 DRAWN BY:

CHECKED BY: R.G.K.

SHEET SHEET 2 OF 2 SHEETS